

§17.44.055.

# PLANNING COMMISSION STAFF REPORT

Categorical Exemption (Class 1)

APPLICATION:	CUP2016-11	AGENDA ITEM:	PH-1			
PREPARED BY:	Teresa Santilena Assistant Planner	MEETING DATE:	May 11, 2016			
SUBJECT:	Conditional Use Permit CUP2 402 – 406 South Myrtle Avenu					
REQUEST:	Allow live indoor entertainment in an existing restaurant (Sow House) in the Historic Commercial Downtown (HCD) zone.					
APPLICANT:	Sow House Monrovia, Rick Ma 402 - 406 South Myrtle Avenue Monrovia, CA 91016					

**BACKGROUND:** The Applicant, Sow House Monrovia (Sow House), is requesting approval of a Conditional Use Permit (CUP) for live indoor entertainment within an existing restaurant in the Historic Commercial Downtown (HCD) zone. Sow House has operated their restaurant at 402-406 South Myrtle Avenue since last year, and currently has approval for indoor and outdoor service of alcohol. The restaurant is located in the commercial space most recently occupied by Café Opera. Since the subject location was not closed for a period of 30 days or more, Café Opera's CUP2001-10 for alcohol service transferred to Sow House. Sow House is currently complying with the conditions of approval set forth in CUP2001-10. The restaurant would now like to augment their business by providing live indoor entertainment. A CUP is required for live entertainment facilities, in order to mitigate any adverse impacts to the surrounding neighborhood in accordance with Monrovia Municipal Code (MMC)

**SUBJECT PROPERTY:** The subject project is located on the southeast corner of South Myrtle and East Lime Avenues. The existing restaurant is located on two lots. According to Los Angeles County Accessor information, the northern of the two lots measures approximately 36 feet wide and 123 1/2 feet deep, for a total lot area of approximately 4,446 square feet, and is improved with a 4,284 square foot building (the historic Monrovia Savings Bank building), which is divided into two tenant spaces. The southern of the two lots measures approximately 55 1/2 feet wide and

**ENVIRONMENTAL DETERMINATION:** 



123 1/2 feet deep for a total lot area of approximately 6,852 square feet and is improved with

an 8,275 square foot building, which is divided into three tenant spaces. The existing restaurant occupies one tenant space in the Monrovia Savings Bank building and one tenant space in the building to the south and has a combined restaurant floor area of approximately 3,819 square feet.

**DISCUSSION/ANALYSIS:** MMC Section 17.44.055 (Entertainment Facilities) was established to provide an appropriate review process for entertainment facilities and to mitigate adverse impacts associated with such establishments through the CUP process. The definition of entertainment facilities includes nightclubs, restaurants, and coffee houses with live entertainment and/or dancing.

#### **Business Operation**

Sow House offers indoor and outdoor dining of fresh, local and organic cuisine and a full bar (Type 47 Department of Alcoholic Beverage Control license) in a casual atmosphere. The hours of operation are 11:00 AM to 10:00 PM, Monday through Wednesday, and 11:00 AM to 2:00 AM Thursday through Sunday. As mentioned earlier in this report, in 2001 Café Opera received approval of CUP2001-10 for indoor and outdoor service of alcohol at this location. The Monrovia Municipal Code requires approval of a new CUP for service of alcohol if a restaurant establishment ceases operation for a period of 30 days or longer (§17.44.025). Since the restaurant was not closed for a period of 30 days or more, a new CUP was not required for Sow House's service of alcohol. Sow House is complying with the conditions of approval set forth in CUP2001-10 related to alcohol service.

#### Floor Plan

The restaurant occupies two adjoining units, with three interconnecting doorways between the two units. As shown on the indoor floor plan, seating is provided within two dining rooms for up to a total of 95 patrons. The floor plan indicates that dining room #1 is located in the Monrovia Savings Bank building and dining room #2 is located in the building to the south. There are two bars, one in each dining room, but bar seating is only available in dining room #2. The kitchen, storage and office are located in the rear and the restrooms are located in the northeast section of the restaurant, off dining room #1.

#### Live Entertainment

The Applicant would like to provide occasional live indoor entertainment in the restaurant. Sow House proposes to use a variety of entertainers, both acoustic and amplified, from solo artists to groups. An approximately 140 square foot stage has been built along the northern wall of the restaurant. The stage can accommodate up to a four person band. The restaurant plans to feature local artists and up-and-coming performers, as well as an occasional "open mike" night.

The location of the stage has been designed to have minimal impact on surrounding businesses. It is situated along the northern wall of the Monrovia Savings Bank building, which is not shared by adjacent businesses. Because Sow House occupies two units, there is sufficient area and buffering between the restaurant and the closest business to the south (Sprint). As conditions of approval, the live entertainment must be conducted within the facility and all exterior doors shall be kept closed during live entertainment, no dance floor is permitted, no cover charge is permitted, and the live entertainment shall not be audible outside the boundaries of the establishment and shall comply with the City's noise and vibration performance standards outlined in MMC §17.32.030 (Performance Standard, Noises) and MMC §17.32.040 (Performance Standard, Vibration).

Additionally, in December, 2015, the Applicant received approval from the Development Review Committee (DRC) for a temporary live indoor entertainment permit for four events, including a New Year's Eve celebration. The City received no complaints related to noise or conduct during the permitted temporary live entertainment dates.

### Parking

The restaurant is located in the Old Town parking district, which is a shared parking arrangement for all commercial uses in Old Town. Parking in the Old Town area can be found on the street and in the public parking lots. There are two public parking lots in close proximity to the existing restaurant, with entrances in the 100 block of East Lemon Avenue and the 100 block of West Lemon Avenue. There are approximately 100 parking spaces in each lot that service the businesses in Old Town.

### Conclusion

The existing restaurant is a permitted use within the HCD Zone and is consistent with surrounding uses. CUP2001-10 for indoor and outdoor service of alcohol remains in effect. The proposed live indoor entertainment requires a CUP to mitigate any adverse impacts related to that aspect of the restaurant's operations. The proposed conditions of approval for the live indoor entertainment will ensure that the restaurant's operations will not negatively impact surrounding properties.

**RECOMMENDATION:** Staff and the DRC recommend approval of CUP2016-11. If the Planning Commission concurs with this recommendation then, following the public hearing, the following actions would be:

- 1. Pursuant to the California Environmental Quality Act ("CEQA") and the City's local CEQA Guidelines, the Planning Commission in the exercise of its independent judgment finds that CUP2016-11 is categorically exempt from CEQA under Class 1.
- 2. The Planning Commission finds that the custodian of records for all other materials that constitute the record of proceeding upon which this decision is based is the Planning Division Manager. Those documents are available for public review in the Planning Division located at 415 South Ivy Avenue, Monrovia, California, 91016.
- 3. The Planning Commission in the exercise of its independent judgment hereby makes the findings listed on attached Data Sheet No. 3 for CUP2016-11, which are incorporated herein by this reference.
- 4. The Planning Commission approves CUP2016-11, subject to the attached Planning Conditions on Data Sheet No. 1, and recommendations in the Staff Report, all of which are incorporated herein by this reference.

### MOTION:

Approve CUP2016-11 pursuant to the recommendations in the Staff Report.

# DATA SHEET 1



CUP2016-11

402 - 406 South Myrtle Avenue

Development of the subject property and operations on the site must remain in substantial conformance at all times with the request and application forms and plans submitted by the Applicant for CUP2016-11, allowing live indoor entertainment in an existing restaurant that serves alcoholic beverages, as approved by the Planning Commission and placed on file in the office of the Planning Division, except as modified by the conditions imposed by the Planning Commission and by subsequent modifications determined by the Planning Division Manager to be in substantial compliance with the conditions of approval. The term "Applicant" as used herein shall include the applicant, the property developer and all successors in interest to this conditional use permit.

- 1. The approved live entertainment shall be permitted indoors and shall be limited to the restaurant's hours of operation: 11:00 AM to 10:00 PM Monday through Wednesday and 11:00 AM to 2:00 AM Thursday through Sunday. Entertainment shall consist of up to four performers. No increase in the number of performers is permitted until reviewed and approved by the Development Review Committee.
- 2. The business hours for live entertainment shall be reviewed by the Development Review Committee for modification if compatibility problems with adjacent uses develop or other nuisance problems develop, and based upon a finding that those problems exist, the DRC may modify the hours of operation, reduce the maximum number for performers below four, or eliminate amplified music. This authorization is in addition to any other authority the DRC has pursuant to the Monrovia Municipal Code. Alternatively, the DRC may refer the matter to the Planning Commission for its review, in which case the Planning Commission may modify the hours of operation if incompatibility with adjacent uses or the existence of other nuisance problems justifies the change, or the Planning Commission may take any other action permitted pursuant to the Monrovia Municipal Code, including modification or revocation of the CUP.
- 3. All entertainment activities shall be conducted entirely within the building and all exterior doors shall be kept closed.
- 4. No cover charge shall be permitted.
- 5. No dancing shall be permitted.
- 6. The live entertainment/amplified music shall not be audible outside the boundaries of the establishment and shall comply with MMC §17.32.030 (Performance Standard, Noises) and MMC §17.32.040 (Vibration).

- 7. The Applicant is prohibited from operating the entertainment activities in any way that adversely affects the peace, health, safety and welfare of residents of the community, and the entertainment activities must not contribute to peace, health, safety and general welfare problems including but not limited to loitering, littering, public drunkenness, defacement, and damaging of structures, pedestrian obstructions as well as traffic circulation, parking and noise problems on public streets and adjacent parking lots. The proposed use shall not at any time create adverse impacts to the commercial district or to any business.
- 8. This conditional use permit may be called for review, including modification or revocation, at any time by City Staff, the City Council, or Planning Commission if a violation of the approved conditions or the Monrovia Municipal Code (MMC) is alleged, or if it is alleged that the establishment, or its patrons, are creating a public nuisance, and such violation or public nuisance is verified as valid by the Police Department, Code Enforcement, or other City department. In the event security/policing problems occur in connection with the entertainment activities, the review may be conducted by the DRC and the DRC is empowered to modify the CUP by requiring additional conditions as determined necessary by the DRC, or the DRC may refer the matter to the Planning Commission for its review, in which case the Planning Commission may take any action permitted pursuant to the MMC, including modification or revocation of the CUP.
- 9. Any violation of these conditions of approval or the Monrovia Municipal Code may be subject to the Administrative Fine Ordinance, other available remedies and/or revocation or modification of this permit at the discretion of the City Attorney and City Prosecutor.
- 10. In addition to Planning (Data Sheet No. 1) conditions of approval, the Applicant shall also comply with all requirements of the Monrovia Municipal Code, Building Division and Fire Department that are directly applicable to the project.
- 11. Indemnification. As a condition of approval, Applicant agrees to defend, indemnify, protect and hold harmless City, its officers, officials, employees, agents and volunteers from and against any and all claims, actions, or proceeding against the City, its officers, officials, employees, agents and/or volunteers to attack, set aside, void or annul, an approval of the City, Planning Commission or City Council concerning this permit and the project. Such indemnification shall include damages, judgments, settlements, penalties, fines, defensive costs or expenses, including, but not limited to, interest, attorneys' fees and expert witness fees, or liability of any kind related to or arising from such claim, action, or proceeding. The city shall promptly notify the Applicant of any claim, action, or proceeding. Nothing contained herein shall prohibit City from participating in a defense of any claim, action or proceeding. The City shall have the option of coordinating the defense, including, but not limited to, choosing counsel for the defense at Applicant's expense.

- 12. The Applicant shall, within 30 days after approval by the Planning Commission, submit to the Community Development Department his/her written consent to all of the conditions of approval contained in Data Sheet Number 1. The CUP shall be void and of no force or effect unless such written consent is submitted to the City within the 30 day period.
- 13. The term "Applicant" as used herein shall include the applicant, the property developer and all successors in interest to this conditional use permit.
- 14. The Development Review Committee shall review the use permitted by the CUP six months from the date the use commences and yearly after the six-month review.
- 15. The use or development associated with this CUP shall begin within one (1) year after its approval or it will expire without further action by the City.
- 16. All of the above conditions shall be complied with prior to commencement of the operation, unless an earlier compliance period is specified as part of a condition.
- 17. The Applicant shall notify the Monrovia Police Department in writing at least seven days in advance of any special events outside the hours when entertainment is allowed including, but not limited to such events as weddings, retirements, Super Bowl or other special parties that are in addition to the normally scheduled events.
- 18. Maximum occupancy for special events shall be determined by the Building Division.
- 19. Prior to the special event Applicant shall provide the Police Department with the contact information for the person who will serve as the direct responsible contact.





CUP2016-11

402 - 406 South Myrtle Avenue

### **CONDITIONAL USE PERMIT 2016-11**

As required by Section 17.52.290 of the Monrovia Municipal Code, the decision for granting Conditional Use Permit No. 2016-11 to allow live indoor entertainment located at 402 - 406 South Myrtle Avenue is based on the following findings:

- A. The project site is adequate in size, shape and topography for live indoor entertainment at the proposed restaurant. It is located in a commercial area that is relatively flat, and the live entertainment will be limited to the restaurant's hours of operation, 11:00 AM to 10:00 PM Monday through Wednesday, and 11:00 AM to 2:00 AM Thursday through Sunday within an enclosed building.
- B. The project site has sufficient access to streets and highways, adequate in width and pavement type to carry the quantity and quality of traffic generated by live indoor entertainment. Sow House will primarily operate as a restaurant with occasional live entertainment. The proposed use is located in a commercial area, which is suited to support these types of uses and traffic loads.
- C. The restaurant with live indoor entertainment is compatible with the General Plan and will not adversely impact the objectives of the General Plan. The project site is located the Historic Commercial Downtown (HCD) zone. The General Plan HCD designation encourages well-designed, pedestrian-oriented commercial uses, such as small shops, banks, and restaurants. As conditions of approval, the live entertainment must be conducted within the facility and all exterior doors shall be kept closed during live entertainment, no dance floor is permitted, and the live entertainment shall not be audible outside the boundaries of the establishment and shall comply with MMC §17.32.030 (Performance Standard, Noises) and MMC §17.32.040 (Vibration).
- D. The proposed live indoor entertainment associated with Sow House will comply with the applicable provisions of the zoning ordinance. There are no variances requested for this CUP. A project condition of approval will further require that the live entertainment shall comply with MMC §17.32.030 (Performance Standard, Noises) and MMC §17.32.040 (Vibration).
- E. The proposed location of live indoor entertainment at Sow House and the conditions under which it will be operated or maintained will not be detrimental to the public health, safety or welfare, nor will it be materially injurious to properties or improvements in the vicinity. *The Applicant will comply with the conditions of approval for providing live entertainment as part of the restaurant operation. The stage area is set up at the northern wall within the restaurant, which is not shared with any other tenant. The restaurant also occupies the northern unit in the*

building to the south, providing an additional buffer. A project condition of approval will further require that the live entertainment shall comply with MMC §17.32.030 (Performance Standard, Noises) and MMC §17.32.040 (Vibration).

Further, as required by Section 17.44.055 of the Monrovia Municipal Code, the decision for granting Conditional Use Permit No. 2016-11 to allow live indoor entertainment at Sow House located at 402 - 406 South Myrtle Avenue is based on the following findings:

- A. The proposed live indoor entertainment (the "proposed use") will not adversely and seriously affect the peace, health, safety and welfare of residents of the community with the conditions of approval insuring that the live entertainment will take place indoors only during limited hours.
- B. The proposed use will not directly contribute to peace, health, safety and general welfare problems including but not limited to loitering, littering, public drunkenness, defacement and damaging of structures, pedestrian obstructions as well as traffic circulation, parking, and noise problems on public streets and adjacent parking lots. *The live indoor entertainment will be required to adhere to the conditions of approval that set forth regulations that are specific to live entertainment and the overall business operation. No cover charge shall be permitted, and no dance floor shall be permitted.*
- C. The proposed use will not create serious adverse impacts to the commercial district. Sow House will primarily operate as a restaurant facility, with occasional live indoor entertainment and will provide a business that is beneficial to the surrounding businesses. A condition of approval requires that the hours of operation for live entertainment activities shall be limited to the restaurant's hours of operation 11:00 AM to 10:00 PM Monday through Wednesday, and 11:00 AM to 2:00 AM Thursday through Sunday.
- D. The proposed use is adequately served by sufficient parking to serve the quantity of traffic such use generates. The restaurant is located in the Historic Commercial Downtown zone that is served by public parking lots. There are two public parking lots in close proximity to the existing restaurant, with entrances in the 100 block of East Lemon Avenue and the 100 block of West Lemon Avenue. There are approximately 100 parking spaces in each lot that service the businesses in Old Town.
- E. The proposed use will not be incompatible with the adjoining uses as it relates to noise, traffic, and hours of operation, as the restaurant will be located within a commercial area of the City and is a compatible use to the surrounding businesses. Conditions of approval require that the live entertainment shall comply with MMC §17.32.030 (Performance Standard, Noises) and MMC §17.32.040 (Vibration), and that all live entertainment activities shall be conducted within the facility only during the restaurant's hours of operation and all exterior doors shall be kept closed during live entertainment.
- F. The proposed use will not negatively impact nearby parks, schools, recreation centers, religious assembly facilities, and hospitals. *The nearby park, Library*

park (located kitty corner from the subject restaurant) will not be negatively impacted because sufficient safeguards exist that will allow the City to exercise control measures that will protect the peace, health, and safety of surrounding properties. Conditions of approval will require that the live entertainment shall comply with MMC §17.32.030 (Performance Standard, Noises) and MMC §17.32.040 (Vibration), and that all live entertainment activities shall be conducted within the facility and all exterior doors shall be kept closed during live entertainment.



**DATA SHEET 4** 

CUP2016-11

### 402 – 406 South Myrtle Avenue

The subject project is located on the southeast corner of **Property Description:** South Myrtle and East Lime Avenues. The existing restaurant is located on two lots. The northern of the two lots measures approximately 36 feet wide and 123 1/2 feet deep, for a total lot area of approximately 4,446 square feet, and is improved with a 4,284 square foot building (the historic Monrovia Savings Bank building). The southern of the two lots measures approximately 55 1/2 feet wide and 123 1/2 feet deep for a total lot area of approximately 6,854 square feet and is improved with an 8,275 square foot building. The existing restaurant occupies one tenant space in the Monrovia Savings Bank building and one tenant space in the building to the south and totals approximately 3,819 square feet. CUP2001-10 was approved for indoor and outdoor service of alcohol at this location.

### Zoning

Subject site: HCD (Historic Commercial Downtown)

Surrounding pattern:

north:	HCD (Historic Commercial Downtown)
south:	HCD (Historic Commercial Downtown)
east:	PD (Planned Development) Area – 5
west:	HCD (Historic Commercial Downtown)

## Land Use

Subject site: Two Commercial Buildings

Surrounding pattern:

north: Restaurant	(Veranda Mediterrar	nean Cuisine)
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- south: Movie Theater (Krikorian)
  - east: Movie Theater (Krikorian)

### west: Commercial Building (Neville Building)

- Environmental Determination: Categorical Exemption Class 1
- Applicable Ordinance MMC 17.52.0 Regulations: CUP

MMC 17.52.020 Planning Commission Authority for CUP

LOS ANCELES COUNTY ENDONMENTAL HEALTH DEDADTMENT	
LOS ANGELES COUNTY ENRONMENTAL HEALTH DEPARTMENT	
SHEET LIST TABLE Sheet Number Sheet Title	_
A0.1 Title Sheet A1.1 Equipment Plan	
A1.2 Sections & Acceptable Matterials List	
A2.0 Reflected Ceiling Plan M1.1 Exhaust Hood Cutsheet	
PROJECT DATA PROJECT NAME: <u>Sow House</u>	
PROJECT ADDRESS: 404 S Myrtle Ave	
Monrovia, CA 91016 BUILDING USE: Commercial	
SCOPE OF WORK: EXISTING RESTAURANT TO RE- ISSUE EXPIRED LICENSE	
PROJECT SIZE: 3784 SQUARE FOOT	
NUMBER OF STORIES: <u>1</u> CONSTRUCTION TYPE: <u>V-A</u>	
FIRE SPRINKLERS: YES	
OCCUPANCY GROUP: A-2	
OCCUPANCY LOAD: <u>75</u>	
PROPERTY TYPE: Commercial Insustrial CODE COMPLIANCE	
2013 CALIFORNIA BUILDING CODE.	
2013 CALIFORNIA ELECTRICAL CODE. 2013 CALIFORNIA MECHANICAL CODE.	
2013 CALIFORNIA PLUMBING CODE.	
	Contraction of the second
ABBREVIATIONS	

			AD.	DICLVIATIONS		
	AC.T.	- ACOUSTIC TILE	ELEV.	– ELEVATION	NIC	- NOT IN CONTRACT
	AFF	– ABOVE FINISH FLOOR – ALTERNATE	EXP	– EXPANSION – EXPANSION JOINT	NO O/A	– NUMBER
			E.J.	– EXPANSION JOINT	0/A	– OVERALL
		– ALUMINUM	EXT	– EXTERIOR	0/C	- ON CENTER
		– ANCHOR		- FLOOR DRAIN	0.D.	– OUTSIDE DIAMETER
	APPROX	– APPROXIMATELY	F.E.	– FIRE EXTINGUISHER	OH	- OVERHELD
	ARCH	_ ARCHITECT/ARCHITECTU	FIN	– FINISH	0/0	- OUT TO OUT
		RAL	FLR	– FLOOR	OPNG	- OPENING
		- BRICK COURSE	FDN	– FOUNDATION	PC	- PIECE
		- BUILDING	FOM	- FACE OF MASONRY	PI	- PLATE
	BLK	– BLOCK – BENCH MARK	FPHB	- FACE OF MASONRY FROST PROOF HOSE BIBB	PL PLAS	– PLASTER
	B.M.	- BENCH MARK		8188	PLBG	- PLUMBING NUMBER
		- BEAM	F.S.	- FLOOR SINK	PLYWD	- PLYWOOD
	B.N.	- BULL NOSE	FTG	— FOOTING	POL	– POLISHED
	BNT	– BENT – BOTTOM – CATCH BASIN – CEMENT	FURR	– FURRING	PROJ	– PROJECT
	BMT	- BOILOW	GA.	– GAUGE	PTD	- PAINTED
	C.B.	- CAICH BASIN	GALV.	– GALVANIZED	R	- RADIUS
			GEN	– GENERAL	R.D.	- ROOF DRAIN
		- CERAMIC TILE	GL	– GLASS/GLAZING	REINF.	- REINFORCEMENT
		- CONTROL JOINT	G.S.	– GRAVEL STOP	REQD.	– REQUIRED
		- CLEAR	GYP.BD.	– GYPSUM BOARD		- ROOM
		- CEILING	HDWE	– HARDWARE	RM R.O.	- ROUGH OPENING
	CMU	- CONCRETE MASONRY UNIT	HB	– HOSE BIBB	S	– SINK
	COL	- COLUMN	H.M. HYD	- HOLLOW METAL	SHT.	- SHEET
	COMP	- COMPOSITION	ΗYD	– HYDRANT		- SHEET METAL
	CONC	– CONCRETE	I.D.	– INSIDE DIAMETER	SQ.	- SQUARE
	CONSTR.	- CONCRETE - CONSTRUCTION - CONTINUOUS - CONTRACTOR	INSUL	– INSULATION	SPM	- SINGLE PLY MEMBRANE
	CONT	- CONTINUOUS	JT	– JOINT	S.S.	- SLOP
	CONTR	- CONTRACTOR	LAV	– LAVATORY	S.S	– STAINLESS STEEL
	CTR.	– CENTER	LG. LT	– LONG – LIGHT	STD	– STANDARD
		- DETAIL	LT	– LIGHT		– STRUCTURAL
		– DRINKING FOUNTAIN	MAR	- MARBLE	SUSP	– SUSPENDED
		– DIAMETER	MAS	- MASONRY	T/	- TOP OF
		– DIMENSION	MAX	- MAXIMUM	T.D.	– TRENCH DRAIN
		- DOOR OPENING	MECH.	- MECHANICAL	TERR	- TERRAZZO
		- DOWNSPOUT	MTL MFR	- METAL	TYP	- TYPICAL
		– DRAWING	MFR	– MANUFACTURER	VCT	VINYL COMPOSITION
		EXT. INSULATION &	MH	– MANHOLE		- TILE
	LII J	FINISH SYSTEM – ELEVATION (SEA LEVEL)	MIN.	- MINIMUM	W.C.	- WATER CLOSET
	EL	– ELEVATION (SEA LEVEL)	MISC.	- MISCELLANEOUS	WD	- WOOD
İ.			11.0		WT	WEIGHT

– ELECTRICAL M.O. – MASONRY OPENING

WT – WEIGHT

ELEC.





# SITE PLAN

# CONSULTANTS

DESIGN BY

DESIGNER / ENGINEER JIS BROTHERS 12368 E VALLEY BLVD. UNIT 115 EL MONTE, CA 91732 CONTACT: ERIC LI PH: (626) 257–0849

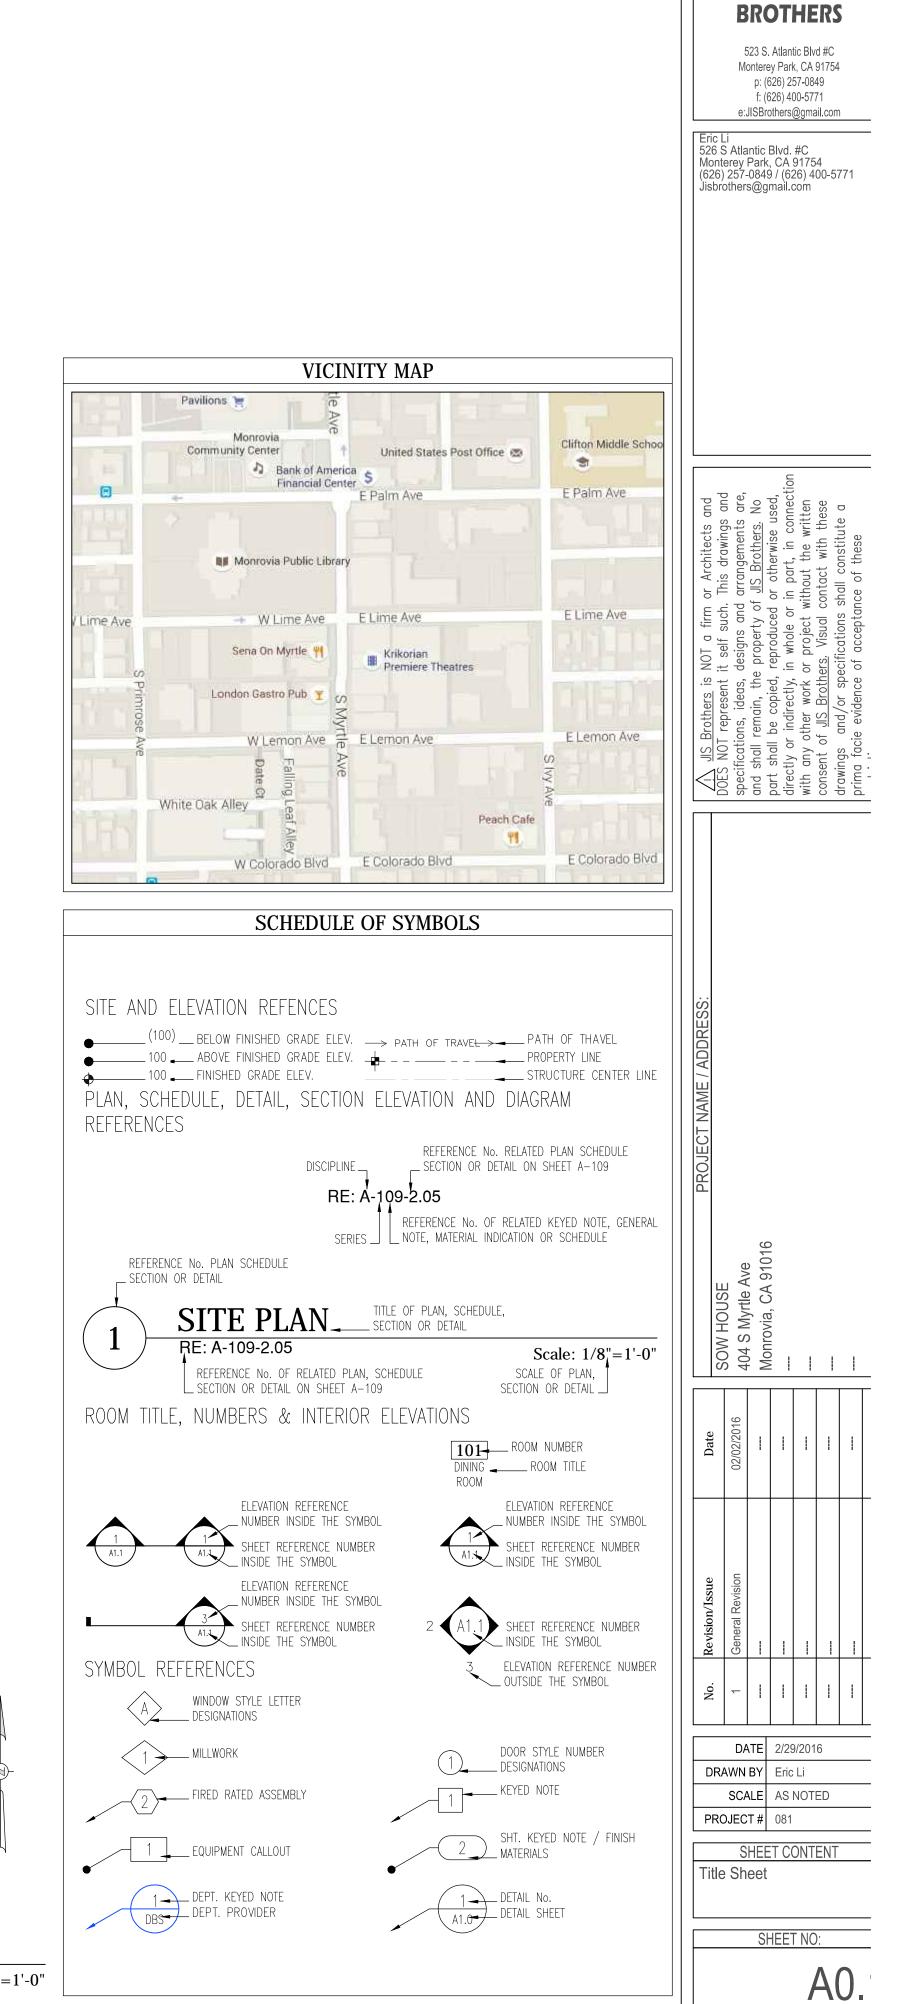
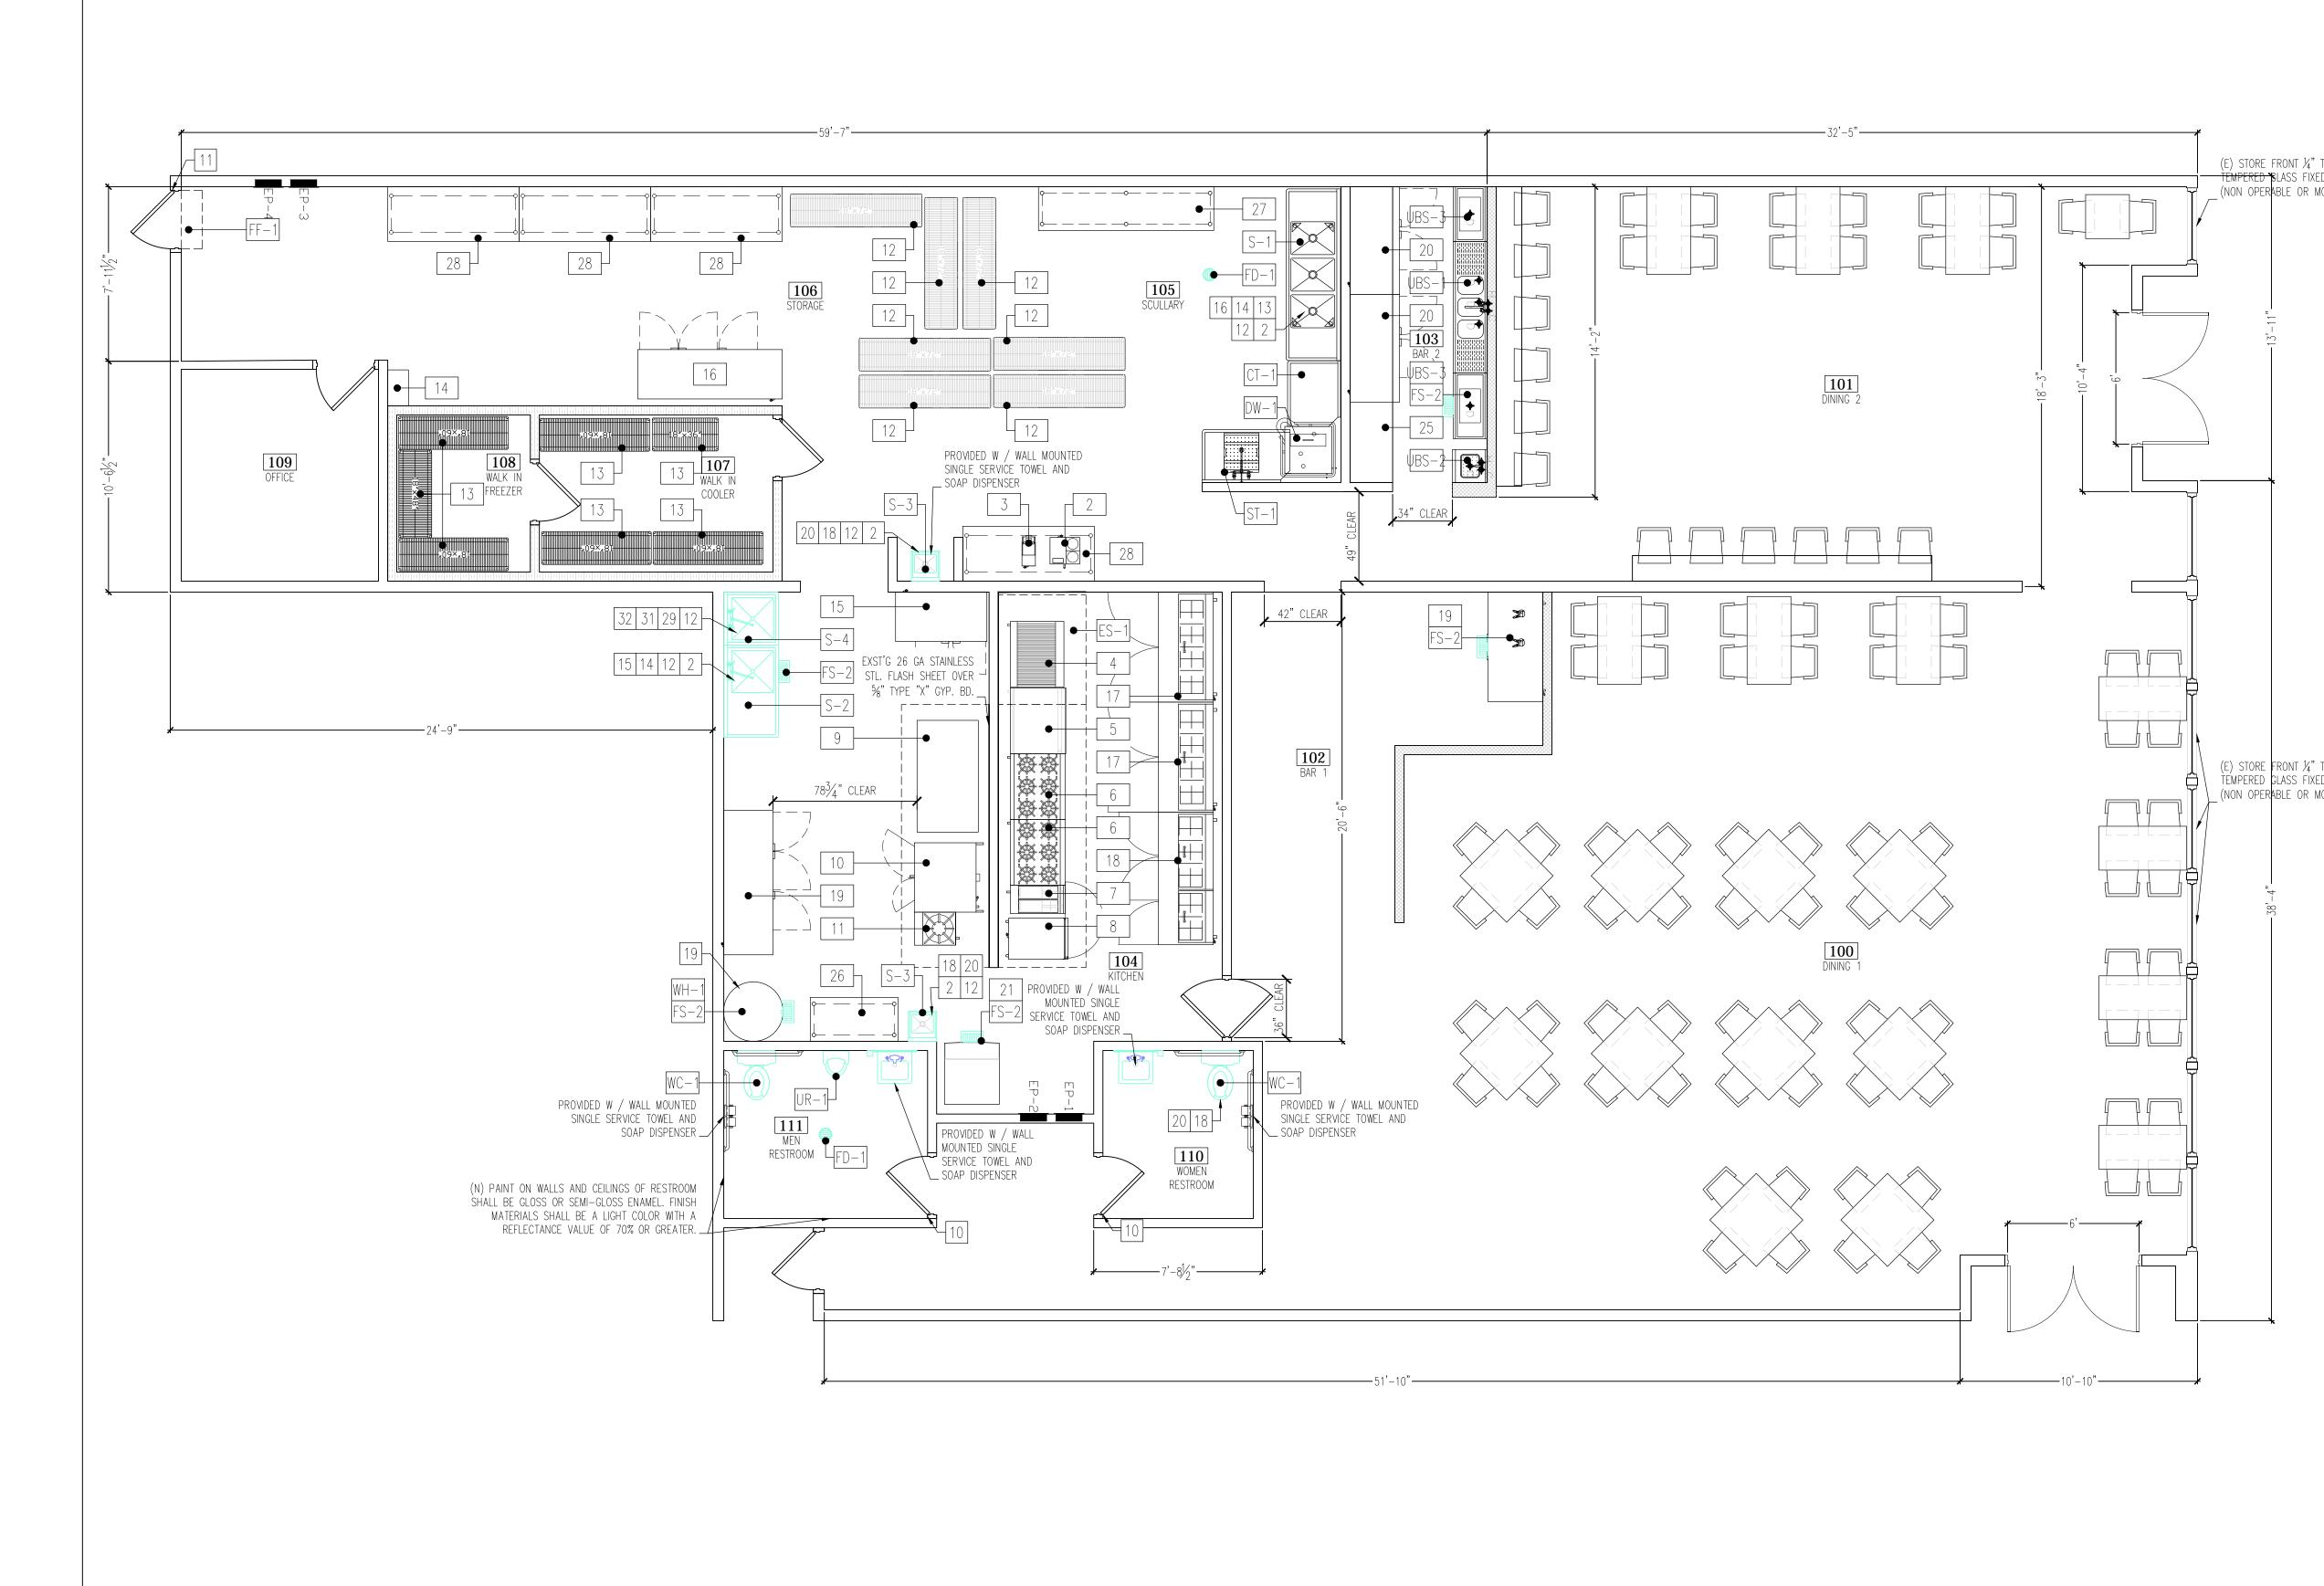
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# EQUIPMENT PLAN

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	ENVIRONMENTAL HEALTH NOTES ALL FOOD-RELATED AND UTENSIL-RELATED EQUIPMENT SHALL MEET OR BE EQUIVALENT TO SANITATION STANDARDS ESTABLISHED BY AN AMERICAN NATIONAL STANDARDS INSTITUTE (ANSI) ACCREDITED PROGRAM. ALL FLOOR MOUNTED EQUIPMENT WILL BE INSTALLED ON MINIMUM 6" SANITARY LEGS, CASTORS, OR ALL FLOOR MOUNTED EQUIPMENT WILL BE INSTALLED ON MINIMUM 6" SANITARY LEGS, CASTORS, OR	
	<ul> <li>COMPLETELY SEALED IN POSITION ON A 4" HIGH CURB WITH CONTINUOUSLY COVED BASE. COUNTERTOP EQUIPMENT WILL BE ON 4" SANITARY LEGS OR SEALED TO THE COUNTER UNLESS READILY MOVABLE.</li> <li>EQUIPMENT THAT IS FIXED BECAUSE IT IS NOT EASILY MOVABLE SHALL BE INSTALLED SO THAT IT IS:</li> <li>(1) SPACED TO ALLOW ACCESS FOR CLEANING ALONG THE SIDES, BEHIND, AND ABOVE THE EQUIPMENT.</li> <li>(2) SPACED FROM ADJOINING EQUIPMENT, WALLS, AND CEILINGS A DISTANCE OF NOT MORE THAN (<sup>1</sup>/<sub>3</sub>2") ONE THIRTY-SECOND INCH.</li> <li>(3) SEALED TO ADJOINING EQUIPMENT OR WALLS, IF THE EQUIPMENT IS EXPOSED TO SPILLAGE OR SEEPAGE.</li> <li>4 FLOOR-MOUNTED EQUIPMENT THAT IS NOT EASILY MOVABLE SHALL BE SEALED TO THE FLOOR (ON A 4" CURB) OR ELEVATED ON (CASTERS OR LEGS) THAT PROVIDE AT LEAST A SIX-INCH CLEARANCE BETWEEN THE FLOOR AND THE EQUIPMENT.</li> <li>5 TABLE-MOUNTED EQUIPMENT THAT IS NOT EASILY MOVABLE SHALL BE INSTALLED TO ALLOW CLEANING OF THE EQUIPMENT AND AREAS UNDERNEATH AND AROUND THE EQUIPMENT BY BEING SEALED TO THE TABLE OR ELEVATED ON LEGS THAT PROVIDE AT LEAST A SIX-INCH CLEARANCE BETWEEN THE FLOOR AND THE EQUIPMENT.</li> <li>6 IF SOFT DRINK, ICE OR OTHER DISPENSERS ARE SELF-SERVICE, OR IF REFILLS ARE PROVIDED THEY AND THE EQUIPMENT.</li> <li>6 IF SOFT DRINK, ICE OR OTHER DISPENSERS ARE SELF-SERVICE, OR IF REFILLS ARE PROVIDED THEY ANY OPENABLE WINDOWS VENT OPENINGS OR OTHER SIMILAR OPENINGS MUST BE PROVIDED THEY FITTING SCREENS OF MINIMUM ½6 MESH. WINDOWS TO BE FIXED AT FOOD PREP, UTENSIL-WASHING, OPEN FOOD AND UTENSIL STORAGE AREAS.</li> <li>8 ALL EXTERIOR DOORS MUST BE EQUIPPED WITH APPROVED SELF-CLOSING DEVICES, EXCEPT FOR "OUTDOOR/OPEN AIR" OPERATIONS OTHERWISE APPROVED BY THIS DEPARTMENT. EACH DOOR MUST BE</li> </ul>	DESIGN BY JIS BROOTHEERS 523 S. Atlantic Blvd #C Monterey Park, CA 91754 p: (626) 257-0849 f: (626) 400-5771 e:JISBrothers@gmail.com
STORE FRONT ¼" THCK. IPERED SLASS FIXED PANELS N OPERABLE OR MOVABLE 11 12 12 12 14 15 15 15 15 15 15 15 15 15 15	<ul> <li>OUIDOOR/OPEN AIR OPERATIONS OTHERWISE APPROVED BY THIS DEPARTMENT. EACH DOOR MUST BE TIGHT-FITTING AND HINGED TO A SOLID WALL, AND NO DOOR STOPPERS ARE SHALL EVER BE USED.</li> <li>BI-FOLD, FRENCH, ACCORDION STYLE AND ROLL-UP DOORS CANNOT OPEN INTO THE FOOD PREP, UTENSIL WASHING OR UNPACKAGED FOOD SERVICE AREAS. WHERE MULTIPLE SETS OF FRENCH DOORS/DOUBLE DOORS ARE PROPOSED, ONE DOOR OF EACH SET MUST BE PERMANENTLY FIXED IN AN APPROVED MANNER SUCH THAT THE HINGES ARE REMOVED AND THE PERMANENTLY FIXED PANEL CAN NO LONGER OPERATE AS A DOOR, BUT MAY STILL RETAIN THE ARCHITECTURAL LOOK OF A FRENCH DOORS SET FROM THE EXTERIOR OF THE BUILDING FOR AESTHETIC REASONS.</li> <li>TOILET ROOM AND DRESSING ROOM DOORS MUST BE SELF-CLOSING, TIGHT FITTING.</li> <li>DELIVERY DOORS TO HAVE AIR CURTAIN FANS THAT SPAN THE WDTH OVER THE DOOR. THE FAN MUST ACTIVATE VIA A MICRO SWITCH PROVIDING A MINIMUM VELOCITY OF 1600 FPM MEASURED AT 36" ABOVE THE GROUND.</li> <li>ALL PLUMBING AND PLUMBING FIXTURES SHALL BE INSTALLED IN COMPLIANCE WITH APPLICABLE LOCAL PLUMBING ORDINANCES, SHALL BE MAINTAINED SO AS TO PREVENT ANY CONTAMINATION, AND SHALL BE KEPT CLEAN, FULLY OPERATIVE AND IN GOOD REPAIR. NO FLEX TUBING OR FLEX LINES WILL BE AAPPROVED. ALL WASTE LINES MUST BE HARD PIPED FROM THE TOP OF COUNTER TO FLOOR SINK.</li> <li>ALL WAREWASHING SINKS TO HAVE 3 COMPARTMENTS THAT ARE A MINIMUM SIZE OF AT LEAST A WALL, IT MUST HAVE AN 8" INTEGRAL BACK SPLASH. HOWEVER, IT MUST BE CAPABLE OF ACCOMMODATING THE LARGEST UTENSIL TO BE WASHED. A WARE WASHING MACHINE DOES NOT SUBSTITUTE FOR THE SINK REQUIREMENT.</li> <li>SINKS TO HAVE SPOUT(S) CAPABLE OF REACHING EACH COMPARTMENT.</li> <li>SINKS TO HAVE SPOUT(S) CAPABLE OF REACHING EACH COMPARTMENT.</li> <li>SINKS TO HAVE SPOUT(S) CAPABLE OF REACHING EACH COMPARTMENT.</li> <li>SINKS TO HAVE SPOUT(S) CAPABLE OF REACHING EACH COMPARTMENT.</li> <li>SINKS TO HAVE SPOUT(S) CAPABLE OF REACHING EACH COMPARTMENT.</li> <li>SINKS TO HAVE SPOUT(S) CAPABLE OF REACHING EACH COMPARTMENT.</li> <li>SINKS TO HAVE</li></ul>	<u>ers</u> is NOT a firm or Architects and esent it self such. This drawings and deas, designs and arrangements are, n, the property of <u>JIS Brothers</u> . No opied, reproduced or otherwise used, ectly, in whole or in part, in connection work or project without the written <u>Brothers</u> . Visual contact with these or specifications shall constitute a dence of acceptance of these
STORE FRONT ¼" THCK. IPERED GLASS FIXED PANELS N OPERABLE OR MOVABLE	<ul> <li>A SEPARATE WET WASTE DOMP TATURE SHALL BE PROVIDED FOR DISPOSAL OF DRIVE OR WASTE ICE OR TO CONSTANTLY SUPPLYING HOT WASTE ICE OR TOWEL DISPENSERS.</li> <li>EACH HAND WASHING SINK MUST HAVE PERMANENTLY MOUNTED SINGLE-SERVICE SOAP AND PAPER TOWEL DISPENSERS.</li> <li>THE HOT WATER HEATER WILL BE A COMMERCIAL TYPE CAPABLE OF CONSTANTLY SUPPLYING HOT WATER TA TEMPERATURE OF 120°F TO ALL SINKS. IN SIZING THE WATER HEATER, THE PEAK HOURLY DEMAND FOR ALL SINKS, ETC., ARE ADDED TOGETHER TO DETERMINE THE MINIMUM REQUIRED RECOVERY RATE.</li> <li>ALL LAVATORES OF HAND SINKS WILL HAVE A COMBINATION FAUCET OR PREMIXING FAUCET CAPABLE OF SUPPLYING WATER TEMPERED TO 100 °F. SELF-CLOSING OR METERED FAUCET TO PROVIDE AT LEAST 15 SECONDS OF WATER WITHOUT REACTIVATION.</li> <li>ALL PLUMBING, ELECTRICAL AND GAS LINES SHALL BE CONCEALED WITHIN THE BUILDING STRUCTURE TO AS GREAT AN EXTENT AS POSSIBLE. ALL EXPOSED CONDUITS, PLUMBING, ETC. SHALL BE INSTALLED AT LEAST 6" OFF FLOOR AND ¾" FROM WALLS USING STANDOFF BRACKETS.</li> <li>CONDUITS, PLUMBING OR PIPING CANNOT BE INSTALLED ACROSS ANY AISLE WAY, TRAFFIC AREA OR DOOR OPENING.</li> <li>BEVERAGE DISPENSING LINES MAY BE ENCLOSED WITHIN WALLS OR FLOORS, OR BE FURRED IN OR ENCASED IN AN APPROVED SEALED ENCLOSURE.</li> <li>MULTIPLE RUNS OR CLUSTERS OF CONDUIT OR PIPELINES SHALL BE FURRED IN OR ENCASED IN AN APPROVED SEALED ENCLOSURE.</li> <li>MULTIPLE RUNS OR CLUSTERS OF CONDUIT OR PIPELINES SHALL BE FURRED IN OR ENCASED IN AN APPROVED SEALED ENCLOSURE.</li> <li>MULLIQUID WASTE SHALL BE DRAINED BY MEANS OF INDIRECT WASTE PIPES INTO A FLOOR SINK. FLOOR SINKS ARE TO BE INSTALLED ALLOW WASTE SHALL BE PROVEND AND HAVE SUITABLE EASILY REMOVABLE SAFETY COVER GRATES.</li> <li>SINKS ARE TO BE INSTALLED FLUSH WITH THE FINISHED FLOOR SURFACE AND HAVE SUITABLE EASILY REMOVABLE SAFETY COVER GRATES.</li> <li>SINKS ARE TO BE INSTALLED FLUSH WITH THE FINISHED FLOOR SURFACE AND HAVE SUITABLE EASILY REMOVABLE SAFETY COVER GRATES.</li> <li>BEVER LINDES ENTER A WALL OR OTHER ENCLOSURE, THE OPENI</li></ul>	NAME / ADDRESS: DOES NOT represent i specifications, ideas, and shall remain, the part shall be copied, directly or indirectly, with any other work of consent of <u>JIS Brothe</u> drawings and/or spe
	<ul> <li>SHALL NOT BE ATTACHED TO A FAUCET OR HOSE BIB UNLESS AN APPROVED BACK FLOW PREVENTER IS PROVIDED.</li> <li>WATER SUPPLY TO CARBONATORS SHALL BE PROTECTED BY AN APPROVED REDUCED PRESSURE PROVIDED.</li> <li>PRINCIPLE BACK FLOW PREVENTER. THE RELIEF VALVE SHALL DRAIN INDIRECTLY TO SEWER WITH A LEGAL AIR GAP.</li> <li>FOR CLEANING FLOOR MATS, THE JANITORIAL SINK TO BE A MINIMUM 24" BY 36" FLOOR-MOUNTED TYPE. MOPS SHALL BE PLACED IN A POSITION THAT ALLOWS THEM TO AIR-DRY WITHOUT SOILING WALLS, EQUIPMENT, OR SUPPLIES.</li> <li>THE JANITORIAL SINK FAUCET WILL HAVE A THREADED OUTER LIP FOR HOSE ATTACHMENT AND AN APPROVED BACK FLOW PREVENTION DEVICE. NO CHEMICAL DISPENSING SYSTEMS OR SHUTOFF VALVES TO BE ATTACHED TO MOP SINK FAUCET OUTLET (UNLESS A "SIDEKICK" PLUMBING DEVICE IS INSTALLED).</li> <li>ALL EQUIPMENT WHICH GENERATES CONDENSATE AND LIQUID WASTES FROM STEAM TABLES, ICC. SHALL BE DRAINED BY MEANS OF INDIRECT WASTE PIPES INTO A FLOOR SINK OR OTHER APPROVED INDIRECT WASTE RECEPTOR, FLOOR DRAINS ARE NOT TO BE USED IN LIEU OF FLOOR SINKS, ETC., SHALL BE DRAINED BY MEANS OF INDIRECT WASTE PIPES INTO A FLOOR SINK OR OTHER APPROVED INDIRECT WASTE RECEPTOR, FLOOR DRAINS ARE NOT TO BE USED IN LIEU OF FLOOR SINKS, ETC., SHALL BE DRAINED BY MEANS OF INDIRECT WASTE PIPES INTO A FLOOR SINK OR OTHER APPROVED INDIRECT WASTE RECEPTOR, FLOOR DRAINS ARE NOT TO BE USED IN LIEU OF FLOOR SINKS, ETC., SHALL BE INSTALLED IN FLOOR STHAT ARE WATER-FLUSHED FOR CLEANING AND IN AREAS TRAP TO BE LOCATED OUTSIDE THE FOOD SERVICE ACTIVITY AREA, FLUSH WITH THE FINISHED FLOOR WHEN INDOORS, LOCAL WASTEWATER DISTRICT OR BUILDING DEPARTMENT TO BE CONTACTED FOR GREASE REMOVAL REQUIREMENTS.</li> <li>FLOOR WHER INDOORS, SCULLERES, AND AT BARS WITH WARE WASHING. FLOOR SURFACES IN AREAS PURSUANT TO THIS SHALL BE SLOPED 1:50 TO THE FLOOR DRAINS.</li> <li>ADECONDARS SCULLERES, AND AT BARS WITH WARE WASHING. FLOOR SURFACES IN AREAS PURSUANT TO THIS SHALL BE SLOPED 1:50 TO THE FLOOR DRAINS.</li> <li>ADE FLOOR FLOONS AND IN DRESSING / CHANGE ROOM(</li></ul>	Date         Date         PROJECT           02/02/2016         SOW HOUSE         SOW HOUSE           02/02/2016         404 S Myrtle Ave         404 S Myrtle Ave             Monrovia, CA 91016
	<ul> <li>AREAS WILL BE A GLOSS OR SEMI-GLOSS ENAMEL. FINISH MATERIAL SHALL BE A LIGHT COLOR IN FOOD PREP AREAS FOR EASY CLEANING.</li> <li>MATERIALS THAT ARE USED IN THE CONSTRUCTION OF UTENSILS AND FOOD-CONTACT SURFACES OF EQUIPMENT SHALL NOT ALLOW THE MIGRATION OF DELETERIOUS SUBSTANCES OR IMPART COLORS, ODORS, OR TASTES TO FOOD AND UNDER NORMAL USE CONDITIONS SHALL BE SAFE, DURABLE, CORROSION-RESISTANT, AND NONABSORBENT, SUFFICIENT IN WEIGHT AND THICKNESS TO WITHSTAND REPEATED WARE WASHING, FINISHED TO HAVE A SMOOTH, EASILY CLEANABLE SURFACE, AND RESISTANT TO PITTING, CHIPPING, CRAZING, SCRATCHING, SCORING, DISTORION, AND DECOMPOSITION.</li> <li>COLD STORAGE ROOMS SHALL BE PROVIDED WITH A SECTION OF SHELVING INSTALLED TO HOLD SHALLOW COOL DOWN PANS NOT TO EXCEED 4" IN HEIGHT. SPACE BETWEEN SHELVING TO BE AT LEAST 8" HIGH.</li> <li>BACKUP DRY STORAGE SHELVING SHALL BE A MINIMUM OF 96 LINEAR FEET (MEASURED WITH TIERS) OR 25% OF KITCHEN, FOOD PREP, AND WORK AREAS, WHICHEVER IS GREATER. SHELVING SHALL BE AT LEAST 18 INCHES DEEP AND START A MINIMUM SIX INCHES OFF THE FLOOR SURFACE.</li> <li>SHELVING OVER WET AREAS (SINKS, MOP SINKS ETC.) AND FOOD PREP SURFACES WILL BE METAL.</li> <li>ALL SEAMS, GAPS, OPENINGS TO BE PROPERLY SEALED.</li> <li>ELECTRICAL POWER SHALL BE SUPPLIED AT ALL TIMES TO OPERATE THE APPROVED EXHAUST, LIGHTING, ELECTRIC WARER HEATERS AND REFRIGERATION UNITS, AND ANY OTHER ACCESSORIES AND APPLIANCES THAT MAY BE INSTALLED IN A FOOD FACILITY.</li> </ul>	Image: second secon
SCALE: 1/4"=1'-0"	2 EQUIPMENT PLAN NOTES SCALE: N. T. S.	SHEET NO:

		1	1						· <b>A</b>			MECH				1
ITEM	QTY.	DESCRIPTION	MANUFACTURER	MODEL	CERT.			-		C. W.	H. W.		anical Wer		AS	REMARKS
No.	<b>Q</b> (1).	DESCRIPTION				VOLT.	PHASE	HP	AMP		1	DIR. Ø				
1	1	POS STATION	BY OWNER			120	1		2.50					KD1011		
2	1	COFFEE MAKER	BLOOMFIELD	1082	UL/NSF	120	1		15.00	1/4						
3	1	COMMERCIAL HOT WATER DISPENSER.	BLOOMFIELD	1222	NSF / UL	120	1		13.30	1/4						RECEPTACLE NEMA 5-15P
S-1	1	(3) COMP. SCULLERY SINK. (3) 18"x24"x12"	ELKAY SSP, LLC	143C18X24218	NSF					1/2	1/2	2				W/(2) SPLASH GUARDS 18" HEIGHT. TO
S-2	1	(1) COMP. FOOD PREP SINK. (1) 24"x24"x12"	ELKAY SSP, LLC	1C24X24L24	NSF					1/2	1/2		1 1/2			PROVIDE 2" DRAINAGE AIR GAP.
S-3	2	HAND SINK, WALL MOUNTED, W/SOAP & TOWEL	ELKAY SSP, LLC	EHS-18-TS	NSF					1/2	1/2	1 1/2				(2) SPLASH GUARDS 6" HEIGHT.
S-4	1	MOP SINK. 20"x16"x6", MOP HANGER & WALL	ELKAY SSP, LLC	FLR-1	NSF					1/2	1/2	2				FAUCET W/ APP. BACKFLOW PREVENTION
CT-1	1	CLEAN TABLE 30"x48"x44-3/4", LT. MTG.	ELKAY SSP, LLC	CDT48L	NSF											16 GA STAINLESS STEEL TOP
DW-1	1	DISH WASHER, CORNER, LOW TEMP, 40 RACKS /	ECOLAB	ES-2000	NSF / UL	115	1		12.00		3/4	2 1/2				WATER CONSUMPTION: 48 GPH PUMP
ST-1	1	SOIL TABLE, 30"x48"44-3/4" W / (1) 20-1/4"x20-1/4"x6"	ELKAY SSP, LLC	DDT48R	NSF					1/2	1/2	2				
FD-1	2	2" FLOOR DRAIN WITH 4" NICKEL BRONZE TOP	WATTS DRAINAGE	FD-100-A	IAPMO					1/2		2				PROVIDE TRAP PRIMER CONNECTION,
FS-2	5	WHT. PORC. ENAMEL COATED FLOOR SINK,	WATTS DRAINAGE	FS-1262-01	IAPMO							1 1/2				W / PLASTIC SEDIMENT BUCKET 2" OUTLE
LV-1	2	WALL HUNG BATHROOM SINK, WHITE W /	AMERICAN STANDARD	Missouri / 0436 - 008US	IAPMO					1/2	1/2	1 1/2				W / SOAP AND PAPER TOWEL DISPENSER
WH-1	1	COMMERCIAL WATER HEATER, 125 KBTUH, 80	AMERICAN STANDARD /	D-80-125-AS	UL					1 1/4	1 1/4		3/4	125	3/4	EXPANSION TANK AND EARTHQUAKE STF
NC-1	2	1.28 GPF ROUND FRONT, TANK TOILET, WHITE	AMERICAN STANDARD	Cadet 3 FloWise /	IAPMO					1/2		3				FLOOR MOUNTED. W/PAPER & SEAT CO
UR-1	1	1.0 GPF URINAL, WHITE	AMERICAN STANDARD	MAYBROOK / 6581 -	IAPMO					3/4		2				WALL MOUNTED, ADA COMPLIANCE, MAN
JBS-1	1	(3) COMP. UNDERBAR SINK. (3) 10"x14"x10"	Krowne	18-63C	NSF					1/2	1/2	2				W/(2) SPLASH GUARDS 6" HEIGHT. TO
JBS-2	1	UNDERBAR HAND SINK, W / SOAP & TOWEL	Glas tender	DHSB-12	NSF					1/2	1/2	1 1/2				(2) SPLASH GUARDS 6" HEIGHT.
JBS-3	2	UNDERBAR ICE BIN, 21"x 30"x 13-1/2"	Krowne	18-30	NSF								1 1/2			PROVIDE 2" DRAINAGE AIR GAP.
ES-1	1	KITCHEN EXHAUST SYSTEM 1														
EH-1	1	SINGLE WALL HOOD / 4x5"EH-1" / 1250 CFM'S		1		120	1		7.50							TYPEI GREASE / 700°F COOKING TEMP
EF-1	1	EXHAUST FAN "EF-1" / 1250 CFM'S CAP.	DELHI "BI"	BI-15		208	3	1 1/2	6.60							ELECTRICALLY INTERLOCK W / "SF-1"
SF-1	1	SUPPLY FAN "SF-1" / 1125 CFM'S CAP.	CHAMPION	3000RLD / RR# 7893		120	1	1/3	7.20	5/8						ELECTRICALLY INTERLOCK W / "EF-1"
FSS-1	1	FIRE SUPPRESION SYSTEM 1			ETL/NSF	120	1		3.50							
ES-2	1	KITCHEN EXHAUST SYSTEM 2														
EH-2	2	SINGLE WALL HOOD / 4x12"EH-2" / 3000 CFM'S		2		120	1		38.33							TYPEI GREASE / 700°F COOKING TEMP
EF-2	2	EXHAUST FAN "EF-2" / 3000 CFM'S CAP.	DELHI	BI-15		208	3	1	4.60							ELECTRICALLY INTERLOCK W / "SF-2"
SF-2	2	SUPPLY FAN "SF-2" / 2700 CFM'S CAP.	CHAMPION	4001DD / RR# 7893		120	3	1/2	9.80	5/8						ELECTRICALLY INTERLOCK W / "EF-2"
SS-2	1	FIRE SUPPRESION SYSTEM 2			ETL/NSF	120	1		3.50							
4	1	GAS RADIANT CHAR-BROILER 36" MOUNTED ON	AMERICAN RANGE	AERB-36	NSF									90	1/2	
5	1	MANUAL, GAS GRIDDLE 36" MOUNTED ON EQ.	AMERICAN RANGE	ARMG-36	NSF									90	1/2	
6	2	RESTAURANT RANGE, 6 BURNERS W / OVEN,	ROYAL Range	RR-6	SA / NSF									215	3/4	
7	1	DEEP FAT FRYER MOUNTED ON 4" CASTERS	AMERICAN RANGE	AF 35-50										120	1/2	PROVIDE GAS "QD" & 6" HEIGHT SPLASH
8	1	COOK-N-HOLD LOW TEMP. RADIANT OVEN, 22-	CRES COR	1000-CH-SS-SPLIT-DE	SA/NSF/	208	1		14.00							REQUIRES NEMA 5-20 RECEPTACLE
9	1	OVEN HEARTHBAKE, PIZZA SINGLE DECK	MONTAGUE	15P-1	SA / NSF									160	3/4	MOUNTED ON 31" LEGS
10	1	OVEN, CONVECTION, BAKERY DEPTH	ROYAL Range	RCOD-1	ETL/NSF	120	1		8.00				1	80	1/2	REQUIRES NEMA 5-20 RECEPTACLE
11	1	STOCK POT (1) BURNER MOUNTED ON 6" LEGS	AMERICAN RANGE	ARSP-18-1	NSF									90	1/2	
12	ASSY	DRY STORAGE WRE SHELVING	METRO INDUSTRIES		NSF											FIVE TIERS DRY FOOD STORAGE
13	ASSY	WALK IN UNIT WIRE SHELVING	METRO INDUSTRIES		NSF											FIVE TIERS NSF APPROVED EPOXY FINISI
14	1	EMPLOYEES LOCKER CABINET W / (6) VENTED	GSW	ELS-6DR	NSF											MUST BE INSTALLED ON SIX (6) INCH HIG
15	1	UNDERCOUNTER REF. / 16.5 ft <sup>3</sup>	BLUE AIR	BAUR60	NSF / UL	115	1	3/8	6.00							SELF CONT. W/ ELEC. EVAPORATOR
16	2	UNDERCOUNTER REF. / 21.4 ft <sup>3</sup>	BLUE AIR	BAUR72	NSF / UL	115	1	3/8	6.10							SELF CONT. W/ ELEC. EVAPORATOR
17	2	SANDWICH / SALAD PREP REF. / 16.5 ft <sup>3</sup>	BLUE AIR	BAPT60	NSF / UL	115	1	3/8	6.00							SELF CONT. W/ ELEC. EVAPORATOR
18	1	SANDWICH / SALAD PREP REF. / 20.0 ft <sup>3</sup>	BLUE AIR	BAPT72	NSF / UL	115	1	3/8	6.10							SELF CONT. W/ ELEC. EVAPORATOR
19	1	BEER DISPENSER COOLER / 23.0 ft3	BLUE AIR	BDD69-3B(s)	NSF / UL	115	1	3/8	6.30				3/4			SELF CONT. W/ ELEC. EVAPORATOR
20	2	BACK BAR COOLER REF. / 19.0 ft <sup>3</sup>	BLUE AIR	BBB59-2B	NSF / UL	115	1	3/8	6.30							SELF CONT. W/ ELEC. EVAPORATOR
21	1	ICE MACHINE, 290 LBS @ 90°F	MANITOWOC	Indigo Series / ID-	NSF / UL	120	1		10.50	3/8			3/4			SELF CONT. DRAINS TO FLOOR SINK.
																OVERHEAD DOOR-SWITCH ACTIVATED, 8"
FF-1	1	AIR CURTAIN UNHEATED 36" W	mars Air Doors	EP236-2U	UL	208	3		8.30							ARFLOW THCK. 1,600 FPM @ 36" FROM
																DISCHARGE
22	1	WALK IN COOLER 80 Sq. Ft	BY CONTRACTOR		NSF											
	1	* LIGHTS			UL											
	1	*EVAPORATOR			UL	208	1		1.20				3/4			REMOTE, DRAINS TO FLOOR SINK.
	1	COMPRESSOR*			UL	208	3		2.16							R-22 REFRIGERANT
23	1	WALK IN FREEZER 52 Sq. Ft	KOOLSTAR													
	1	LIGHTS	KASON													
	1	* EVAPORATOR			UL	230			1.20				3/4			REMOTE, DRAINS TO FLOOR SINK.
	1	* DEFROSTER			UL	230			8.80							
	1	* COMPRESSOR			UL	230			4.65							R-22 REFRIGERANT
			1	1			. ·			•	1	1	1		1	
24	1	BAR COUNTER	CONTRACTOR/INSTALLER TO													16 GA STAINLESS STEEL TOP
25	1	BACK BAR COUNTER	CONTRACTOR/INSTALLER TO		1	1				1			1			WOOD / FORMICA LAMINATED INTERIORS
26	1	W. TABLE W/ UNDERSHELF, 2' x 4'	ALLSTRONG	WT-2448-C	NSF											16 GA STAINLESS STEEL TOP
27	1	W. TABLE W/ UNDERSHELF, 2'x 6'	ALLSTRONG	WT-2472-C	NSF											16 GA STAINLESS STEEL TOP
				WT-3072-C	NSF	ł	+									16 GA STAINLESS STEEL TOP
28	4	W. TABLE W / UNDERSHELF, 2'-6" x 6'	ALLSTRONG	VVI=.3U72=C							1					

\* ALL EQUIPMENT SHALL BE ASILY MOVABLE (E. G. ON CASTERS), ON 6" LEGS / CLEARANCE FROM THE FLOOR OR SEALED TO MIN. 4" SOLID MASONRY ISLAND WITH MIN. 3/8" COVED BASE. IF ON AN ISLAND, IT SHALL OVERHANG THE BASE AT LEAST 2" BUT NO MORE THAN \* ALL NEW AND REPLACEMENT FOOD-RELATED AND UTENSIL-RELATED EQUIPMENT SHALL BE CERTIFIED OR CLASSIFIED FOR SANITATION BY AN AMERICAN NATIONAL STANDARDS INSTITUTE (ANSI) ACCREDITED CERTIFICATION PROGRAM. \* HEATING ELEMENTS IN WATER HEATER WIRED FOR TWIN OPERATION.

# EQUIPMENT SCHEDULE

	ACCEPTED CONCRETE SEALERS AND TILES LIST						
PRODUCT	MANUFACTURER	CONTACT INFORMATION	HEAT RESISTANT				
ACRI-SHEEN	PAUL WOLF COMPANY	(877) 974-0630 www.paulwolf.com					
AMERLOCK 2 VOC	PPG PROTECTIVE & MARINE COATINGS	John Woods (Sales) (562) 691-9600 www.ppgpmc.com	yes				
AQUA MIXSEALER'S CHOICE GOLD	AQUA MIX INC.	(800) 366-6877 www.aquamix.com					
CEMENTONE	L. M. SCOFIELD, Co.	(800) 800-9900 www.scotfield.com					
ELASTAGLAZE	DEX-O-TEX	(310) 886-9100					
EPOX-O-SHEEN	PAUL WOLF COMPANY	(877) 974-0630 www.paulwolf.com					
PEGA-COTE 9200	ABC CONSTRUCTION SPECIALTIES	(800) 201-0222 www.abcconstructionspecialties.com					
PERMASEAL	MONOPOLE, INC.	(818) 500-8585 www.monopoleinc.com					
POSI-TRED CR / NOVOLAC EPOXY	DEX-O-TEX	(310) 886-9100	yes				
RES-CRETE RC H20	PACIFIC POLYMERS	(714) 898-0025 www.pacpoly.com					
ROYAL SHEEN	PAUL WOLF COMPANY	(877) 974-0630 www.paulwolf.com					
RUSTOLEOM 6500 / 100% SOLID EPOXY	RUSTOLEUM	(800) 553–8444	yes				
SELECT EPOXY-COTE WB-88	SELECT PRODUCTS COMPANY	(714) 429-0808 / (877) 633-2750					
SHERWIN-WILLIAMS #3589 EPOXY COAT	SHERWIN-WILLIAMS COMPANY	www.generalpolymers.com					
SHUR SEAL	PAUL WOLF COMPANY	(877) 974-0630 www.paulwolf.com					
THERMOSHEEN	PAUL WOLF COMPANY	(877) 974-0630 www.paulwolf.com	yes				

ADDITIONAL NOTES:

CALIFORNIA PLUMBING CODE 2010 EDITION-CHAPTER 6, WATER SUPPLY AND DISTRIBUTION-SECTION 604.0, MATERIALS/604.1 – ALL PIPE, TUBE, AND FITTINGS CARRYING WATER USED IN POTABLE WATER SYSTEMS
INTENDED TO SUPPLY DRINKING WATER SHALL MEET THE REQUIREMENTS OF NSF 61, STANDARD FOR DRINKING WATER SYSTEM COMPONENTS, AS FOUND IN TABLE 14–1.

MATERIALS FOR BUILDING WATER PIPING AND BUILDING SUPPLY PIPING SHALL BE IN ACCORDANCE WITH THE APPLICABLE STANDARDS REFERENCED IN TABLE 6–4. ACCORDING TO TABLE 6-4, PEX TUBING MATERIALS ARE ADOPTED BY THE BUILDING STANDARDS COMMISSION (BSC) WITH THE CONDITION THAT:

WHEN PEX TUBING IS PLACED IN SOIL AND IS USED IN POTABLE WATER SYSTEMS INTENDED TO SUPPLY DRINKING WATER TO FIXTURES OR APPLIANCES, THE TUBING OR PIPING SHALL BE SLEEVED WITH A MATERIAL APPROVED FOR POTABLE WATER USE IN SOIL OR OTHER MATERIAL THAT IS IMPERMEABLE TO SOLVENTS OR PETROLEUM PRODUCTS. PEX TUBING SHALL MEET OR EXCEED THE REQUIREMENTS OF ASTM-F876-08 OR AN EQUIVALENT OR MORE STRINGENT STANDARD WHEN USED IN CONTINUOUSLY RECIRCULATING HOT WATER SYSTEMS AND THE PEX TUBING IS EXPOSED TO THE HOT WATER 100% OF THE TIME.

AT NO TIME IS THE USE OF PEX-AL-PEX IN A POTABLE WATER SUPPLY SYSTEM EVER APPROVED. NOT CURRENTLY ADOPTED BY THE BSC.

FEDERAL LAW REQUIRES RETAIL FOOD FACILITIES THAT BOTTLE JUICE THAT HAS NOT BEEN TREATED TO ACHIEVE A 5-LOG REDUCTION IN PATHOGENS (PASTEURIZATION IS THE MOST COMMON WAY TO ACHIEVE THE 5-OLG REDUCTION), TO PLACE A CONSUMER WARNING LABEL ON THE CONTAINER PRIOR TO OFFERING FOR SALE.

THE LANGUAGE FOR THE WARNING IS FOUND IN 21CFR 101.17(G). PLEASE NOTE THAT THE WARNING ONLY APPLIES TO BOTTLED/PACKAGED JUICE PRODUCTS AND DOES NOT APPLY TO JUICE SOLD BY THE GLASS TO CONSUMERS.

• SUBMIT A BLD PERMIT NUMBER.

SCALE: N. T. S.

ROOM NAME	FLOOR	FINISH SCHEDULE	WALLS	CEILING
DINING	SMOOTH CERAMIC TILE, COMMERCIAL GRADE.	4"x1/8" THERMOPLASTIC RUBBER W / 3/8" COVE RADIUS.	GYPSUM BOARD; SMOOTH; SEMI-GLOSS PAINT SWISS COFFEE.	GYPSUM BOARD; SMOOTH; SEMI-( PAINT NAVAJO WHITE.
DINING	SMOOTH CERAMIC TILE, COMMERCIAL GRADE.	4" QUARRY TILE W / 3/8" COVE RADIUS.	GYPSUM BOARD; SMOOTH; SEMI-GLOSS PAINT SWISS COFFEE.	GYPSUM BOARD; SMOOTH; SEMI-( PAINT NAVAJO WHITE.
BAR	SMOOTH QUARRY TILE.	S3619T SLIMFOOT CERAMIC TILE W / 3/8" COVE RADIUS.	GYPSUM BOARD; SMOOTH; SEMI-GLOSS PAINT NAVAJO WHITE.	GYPSUM BOARD; SMOOTH; SEMI-( PAINT NAVAJO WHITE.
BAR	SMOOTH QUARRY TILE.	S3619T SLIMFOOT CERAMIC TILE W / 3/8" COVE RADIUS.	GYPSUM BOARD; SMOOTH; SEMI-GLOSS PAINT NAVAJO WHITE.	GYPSUM BOARD; SMOOTH; SEMI-( PAINT NAVAJO WHITE.
KITCHEN	SMOOTH QUARRY TILE.	S3619T SLIMFOOT CERAMIC TILE W / 3/8" COVE RADIUS.	GYPSUM BOARD; SMOOTH; SEMI-GLOSS PAINT NAVAJO WHITE.	GYPSUM BOARD; SMOOTH; SEMI- PAINT NAVAJO WHITE.
SCULLARY	SMOOTH QUARRY TILE.	S3619T SLIMFOOT CERAMIC TILE W / 3/8" COVE RADIUS.	GYPSUM BOARD; SMOOTH; SEMI-GLOSS PAINT NAVAJO WHITE.	GYPSUM BOARD; SMOOTH; SEMI- PAINT NAVAJO WHITE.
STORAGE	SMOOTH QUARRY TILE.	S3619T SLIMFOOT CERAMIC TILE W / 3/8" COVE RADIUS.	GYPSUM BOARD; SMOOTH; SEMI-GLOSS PAINT NAVAJO WHITE.	GYPSUM BOARD; SMOOTH; SEMI- PAINT NAVAJO WHITE.
WALK IN COOLER	SMOOTH QUARRY TILE.	6" STAINLESS STEEL W / 3/8" COVE RADIUS.	STUCCO WHITE EMBOSSED GALVANIZED PANELS U. S. D. A. APPROVED.	STUCCO WHITE EMBOSSED GALV PANELS U. S. D. A. APPROVE
WALK IN FREEZER	SMOOTH QUARRY TILE.	6" STAINLESS STEEL W / 3/8" COVE RADIUS.	STUCCO WHITE EMBOSSED GALVANIZED PANELS U. S. D. A. APPROVED.	STUCCO WHITE EMBOSSED GALV PANELS U. S. D. A. APPROVE
OFFICE	SMOOTH CERAMIC TILE, COMMERCIAL GRADE.	4"x1/8" THERMOPLASTIC RUBBER W / 3/8" COVE RADIUS.	GYPSUM BOARD; SMOOTH; SEMI-GLOSS PAINT SWISS COFFEE.	GYPSUM BOARD; SMOOTH; SEMI- PAINT NAVAJO WHITE.
WOMEN RESTROOM	SMOOTH QUARRY TILE.	S3619T SLIMFOOT CERAMIC TILE W / 3/8" COVE RADIUS.	GYPSUM BOARD; SMOOTH; SEMI-GLOSS PAINT NAVAJO WHITE.	GYPSUM BOARD; SMOOTH; SEMI- PAINT NAVAJO WHITE.
MEN RESTROOM	SMOOTH QUARRY TILE.	S3619T SLIMFOOT CERAMIC TILE W / 3/8" COVE RADIUS.	GYPSUM BOARD; SMOOTH; SEMI-GLOSS PAINT NAVAJO WHITE.	GYPSUM BOARD; SMOOTH; SEMI- PAINT NAVAJO WHITE.

**ROOM FINISH SCHEDULE** ALUMI

MARK	LOCATION	COND.		SIZE				
		(*)	WIDTH	HEIGTH	THICK	MAT		
	DINING	(E)	6'-0"	6'-8"	1-1/2"	ALUMIN THCK. T GLASS		
	DINING	(E)	6'-0"	6'-8"	1-1/2"	ALUMIN THCK. 1 GLASS		
	STORAGE	(E)	3'-0"	6'-8"	1-1/2"	STEEL		
	WALK IN COOLER	(E)	3'-0"	6'-8"	1-1/2"	SOLI		
	WALK IN FREEZER	(E)	3'-0"	6'-8"	1-1/2"	SOLIE		
	OFFICE	(E)	3'-0"	6'-8"	1-1/2"	CORRUGA / WOOD		
	WOMEN RESTROOM	(E)	3'-0"	6'-8"	1-1/2"	CORRUGA / WOOD		
	MEN RESTROOM	(E)	3'-0"	6'-8"	1-1/2"	CORRUGA / WOOD		

	DOOR	CONDITION			DOOR R	EMARK	S
	(E)	THE ITEM IS EXIS	TING & T	O REMAIN	DC -	сомм	ERCI
	(R)	ITEM TO REMOVE	-			UL CER	TIFIE
	(RL)	ITEM TO RE-LOCA	ATE		FR 90 -	90 MIN	. FIRE
	(N)	THE ITEM IS NEW	1			EXTERI	OR D
					FR 20 -	20 MIN	. FIRE
$\frown$	-						



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# DOOR SCHEDULE

\* COVE BASE IS SMOOTH WITH MIN. HEIGHT 4".

\* FLOOR FINISH TO BE SMOOTH UNDERNEATH ALL FOOD EQUIPMENT / SHELVES.

\* ALL PERMANENT FOOD FACILITIES SHALL BE FULLY ENCLOSED IN A BUILDING CONSISTING OF PERMANENT FLOORS, WALLS AND AN OVERHEAD STRUCTURE.

EXCEPTION: OUTDOOR BBQS, OUTDOOR DINING AREAS, PRODUCE STANDS AND SWAP MEET PREPACKAGED

	DOO	R SCHEDULE	
DOOR		FRAME	
RIAL	FINISH	MAT ERIAL	FI
M W / 1/4"	ANODIZED		ANO
MPERED	ALUMINUM	ALUMINUM / HOLLOW	ALUI

DOOR SCHEDULE										
DOOR		FRAME		DETAILS			REMARKS			
MATERIAL FINISH		MATERIAL	FINISH	HEAD	JAMB	THRESH.				
ALUMINUM W / 1/4" THCK. TEMPERED GLASS PANELS.	ANODIZED ALUMINUM	ALUMINUM / HOLLOW	ANODIZED ALUMINUM			1/2"	DC	TF	P/P	WB
ALUMINUM W / 1/4" THCK. TEMPERED GLASS PANELS.	ANODIZED ALUMINUM	ALUMINUM / HOLLOW	ANODIZED ALUMINUM			1/2"	DC	TF	P/P	WB
STEEL / HOLLOW.	PRIMED GRAY.	STEEL / HOLLOW.	PRIMED GRAY.			1/2"	DC WB	FR20 PB	LT	TF
Solid Wood.	STUCCO WHITE EMBOSSE	STAINLESS STEEL / HOLLOW; W / 96 IN VISION PANEL.	STUCCO WHITE EMBOSSE			FLUSHED W/FLOOR.	DC	FR20	TF	
Solid Wood.	STUCCO WHITE EMBOSSE	STAINLESS STEEL / HOLLOW; W / 96 IN VISION PANEL.	STUCCO WHITE EMBOSSE			FLUSHED W/FLOOR.	DC	FR20	TF	
CORRUGATED CELL W / WOOD VENEER.	NATURAL WOOD SEALED.	STEEL / HOLLOW.	gloss Dark Brown.			1/2"	DC WB	FR20	LT	TF
CORRUGATED CELL W / WOOD VENEER.	NATURAL WOOD SEALED.	STEEL / HOLLOW.	gloss Dark Brown.			1/2"	DC WB	FR20	LT	TF
CORRUGATED CELL W / WOOD VENEER.	NATURAL WOOD SEALED.	STEEL / HOLLOW.	GLOSS DARK BROWN.			1/2"	DC WB	FR20	LT	TF

CIAL DOOR CLOSER / IED / ADA COMPLIANCE RE RATED STEEL DOOR. RE RATED INTERIOR

**PB** - EQUIPPED W / PANIC BAR HARDWARE; OPERATED W / SINGLE PUSH EFFORT.

LT - EQUIPPED W / KEYED ENTRY LEVER; OPERATED W / SINGLE LEVER

P/P- EQUIPPED W / BACK PULL BEVELLED HANDLE & PUSH BAR; UNLATCHED

EFFORT.

94 X 8 DATE 2/29/2016 DRAWN BY Eric Li SCALE AS NOTED PROJECT # 081 SHEET CONTENT Schedules & Acceptable Matterials List SHEET NO: A1.2

SCALE: N. T. S.


SCALE: N. T. S.

DESIGN BY JIS **BROTHERS** 

523 S. Atlantic Blvd #C Monterey Park, CA 91754 p: (626) 257-0849 f: (626) 400-5771 e:JISBrothers@gmail.com

526 S Atlantic Blvd. #C Monterey Park, CA 91754 (626) 257-0849 / (626) 400-5771 Jisbrothers@gmail.com

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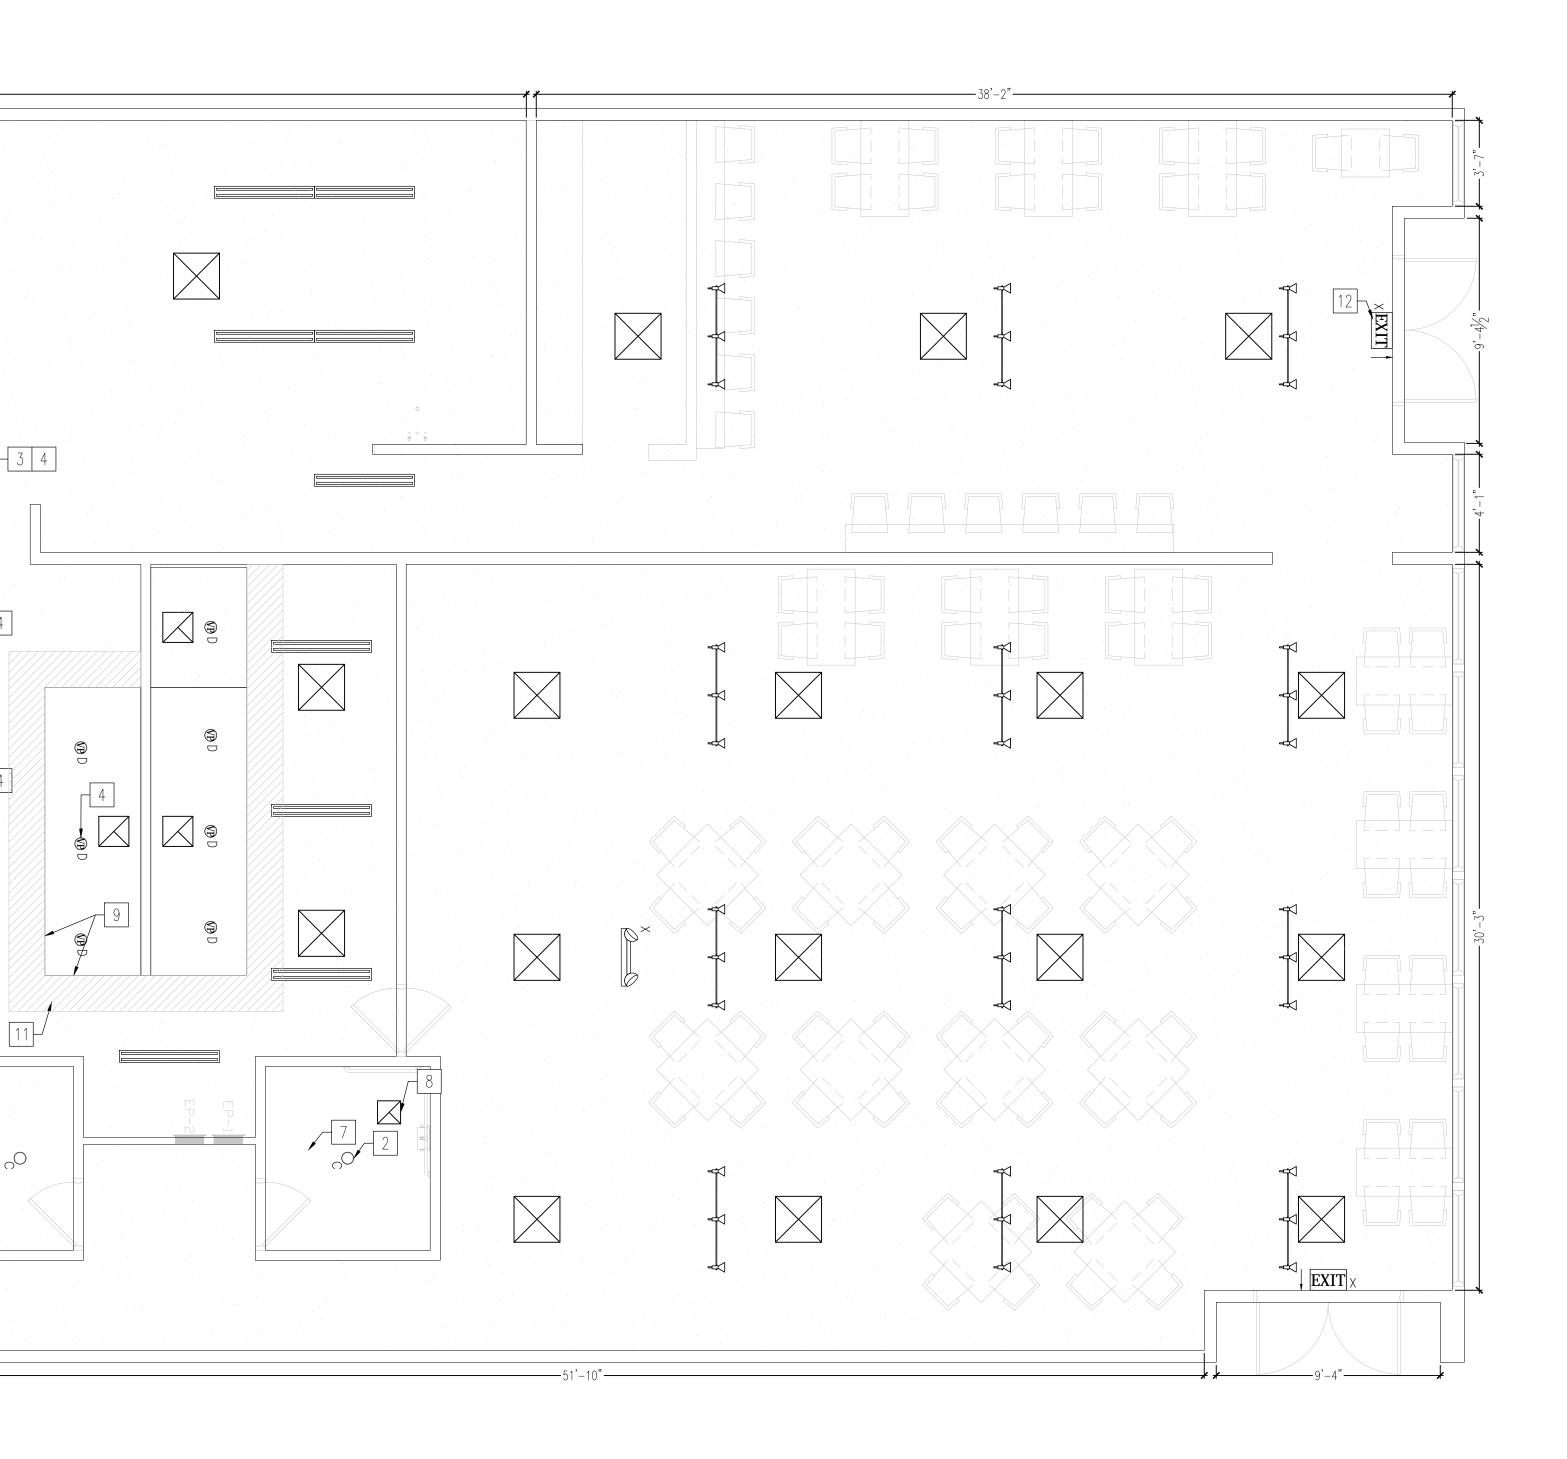
# **REFLECTED CEILING PLAN**
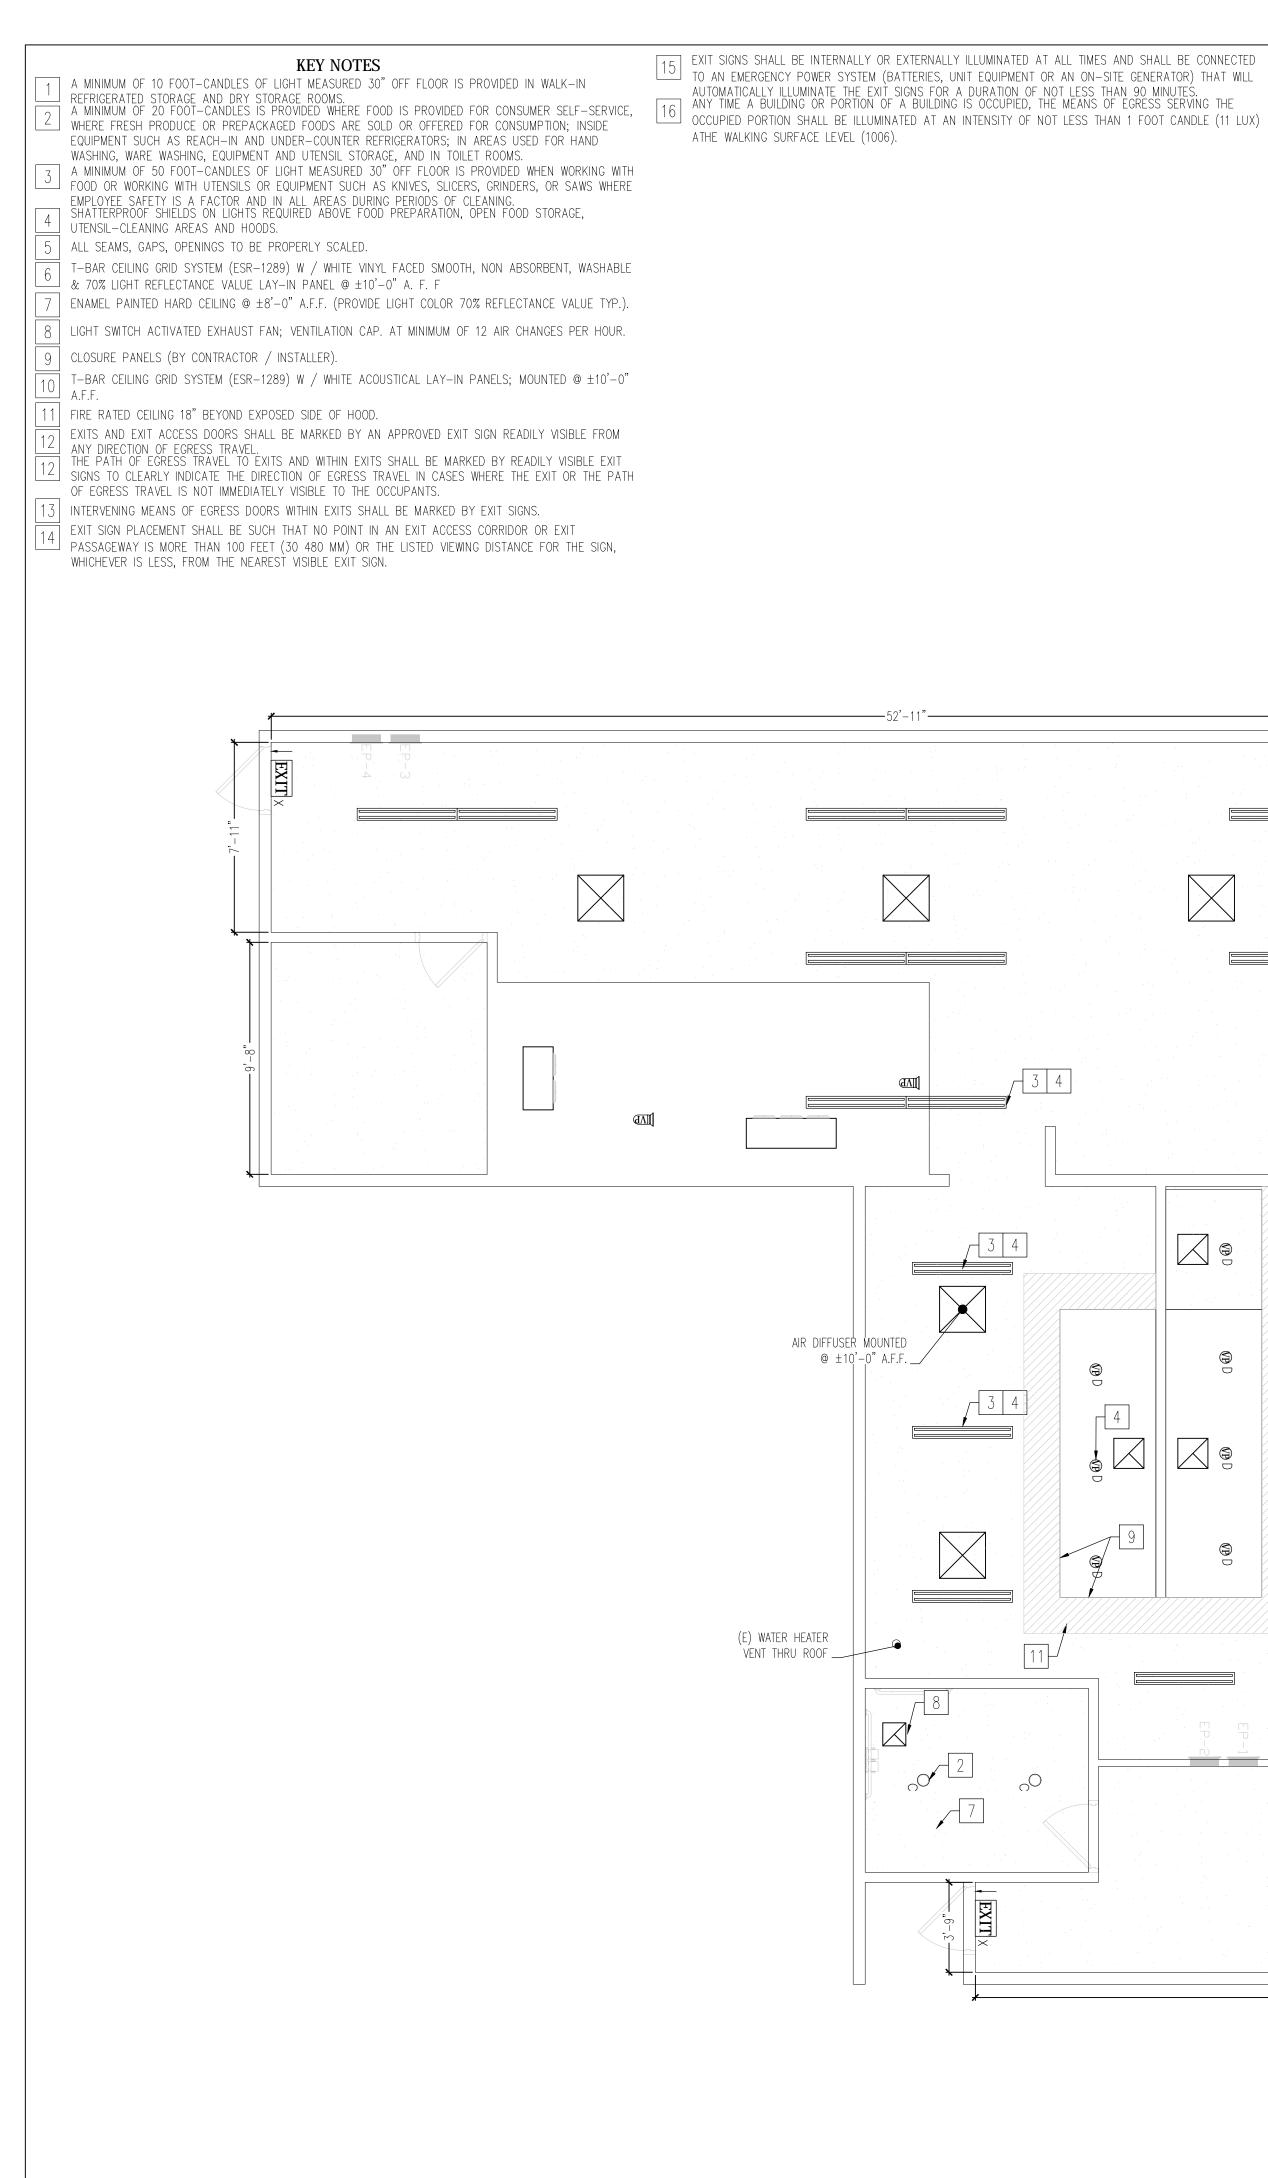
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# EXIT SIGNS

- a. EXIT SIGNS SHALL BE INTERNALLY OR EXTERNALLY ILLUMINATED. b. INTERNALLY ILLUMINATED EXIT SIGNS SHALL BE LISTED AND LABELED IN ACCORDANCE WITH UL 924 AND SHALL BE INSTALLED IN ACCORDANCE WITH THE MANUFACTURER'S INSTRUCTIONS AND
- CHAPTER 27 c. EXTERNALLY ILLUMINATED EXITS SIGNS SHALL COMPLY WITH THE GRAPHICS AND POWER SOURCE
- REQUIREMENTS IN SECTIONS 1011.5.1 AND 1011.5.3, RESPECTIVELY. d. WHEN THE FACE OF AN EXIT SIGN IS ILLUMINATED FROM AN EXTERNAL SOURCE, IT SHALL HAVE AN INTENSITY OF NOT LESS THAN 5–FOOT–CANDLES (54 IUX). 2.-EXIT SIGNS POWER SUPPLY
- THE POWER SUPPLY FOR MEANS OF EGRESS ILLUMINATION SHALL BE PROVIDED BY THE PREMISES ELECTRICAL SUPPLY; IN THE EVENT OF POWER SUPPLY FAILURE, ILLUMINATION SHALL BE AUTOMATICALLY PROVIDED FROM AN EMERGENCY SYSTEM FOR THE FOLLOWING AREAS: a. AISLES AND UNENCLOSED EGRESS STAIRWAYS IN ROOMS AND SPACES THAT REQUIRE TWO OR MORE
- MEANS OF EGRESS. b. CORRIDORS, EXIT ENCLOSURES, AND EXIT PASSAGEWAYS IN BUILDINGS REQUIRED TO HAVE TWO OR
- MORE EXITS. c. EXTERIOR EGRESS COMPONENTS AT OTHER THAN THE LEVEL OF EXIT DISCHARGE UNTIL EXIT
- DISCHARGE IS ACCOMPLISHED FOR BUILDINGS REQUIRED TO HAVE TWO OR MORE EXITS.
- d. INTERIOR EXIT DISCHARGE ELEMENTS, AS PERMITTED IN SECTION 1027.1, IN BUILDINGS REQUIRED TO HAVE TWO OR MORE EXITS. e. EXTERIOR LANDINGS, AS REQUIRED BY SECTION 1008.1.6, FOR EXIT DISCHARGE DOORWAYS IN
- BUILDINGS REQUIRED TO HAVE TWO OR MORE EXITS.
- 3.-EXIT SIGNS EMERGENCY POWER SUPPLY a. THE EXIT SIGNS SHALL ALSO BE CONNECTED TO AN EMERGENCY ELECTRICAL SYSTEM WHICH IS TO PROVIDE CONTINUED ILLUMINATION FOR A DURATION OF NOT LESS THAN 1  $rac{1}{2}$  HR. b. IN CASE OF PRIMARY POWER LOSS. CONTINUED ILLUMINATION IS TO BE PROVIDED FROM STORAGE BATTERIES, UNIT EQUIPMENT, OR AN ON-SITE GENERATOR AND THE INSTALLATION OF THE
- EMERGENCY POWER SYSTEM SHALL BE INSTALLED IN ACCORDANCE WITH CHAPTER 27. 4.-EMERGENCY LIGHTING a. EMERGENCY LIGHTING FACILITIES SHALL BE ARRANGED TO PROVIDE INITIAL ILLUMINATION THAT IS
- AT LEAST AN AVERAGE OF 1-FOOT-CANDLE (11 LUX) AND A MINIMUM AT ANY POINT OF 0.1-FOOT-CANDLE (1 LUX) MEASURED ALONG THE PATH OF EGRESS AT FLOOR LEVEL.
- b. A MAXIMUM-TO-MINIMUM ILLUMINATION UNIFORMITY RATIO OF 40 TO 1 SHALL NOT BE EXCEEDED.



REFLEC	TED CEILING PLAN SYMBOLS	
SYMBOL	DESCRIPTION	
0	6"¢ CANNED LED LIGHT FIXTURE W / ACRYLIC LENSES	
∞	4"ø pendant light fixture	
(P)	EXHAUST HOOD FLUORESCENT LIGHT W / VAPOR – SHATTERPROOF ENCLOSURE.	
IVP	REFRIGERATED WALK IN UNIT FLUORESCENT LIGHT W / VAPOR – SHATTERPROOF ENCLOSURE.	
	2x4 FLUORESCENT LIGHT (3) BULBS / SHATTERPROOF ACRYLIC COVER	DESIGN BY
	LENSES & METAL HOUSING, CEILING SURFACE MOUNTED.	JIS
EXIT	LED EXIT SIGN. PROVIDED W $/$ 90 MIN. POWER BACKUP.	BROTHERS
	BUG EYE EMERGENCY LIGHT. PROVIDED W $/$ 90 MIN. POWER BACKUP.	523 S. Atlantic Blvd #C Monterey Park, CA 91754
	12"x12" AIR RETURN PLENUM.	p: (626) 257-0849 f: (626) 400-5771
	12"x12" AIR SUPPLY PLENUM.	e:JISBrothers@gmail.com
	$5\!\!\%$ " TYPE "X" GYPSUM BOARD (SEE FINISH SCHEDULE FOR CEILING	Eric Li 526 S Atlantic Blvd. #C Monterey Park, CA 91754
	PANEL DETAILS).	(626) 257-0849 / (626) 400-5771 Jisbrothers@gmail.com

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SOV 404 1

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DATE 2/29/2016

SCALE AS NOTED

SHEET CONTENT Reflected Ceiling Plan

DRAWN BY Eric Li


PROJECT # 081

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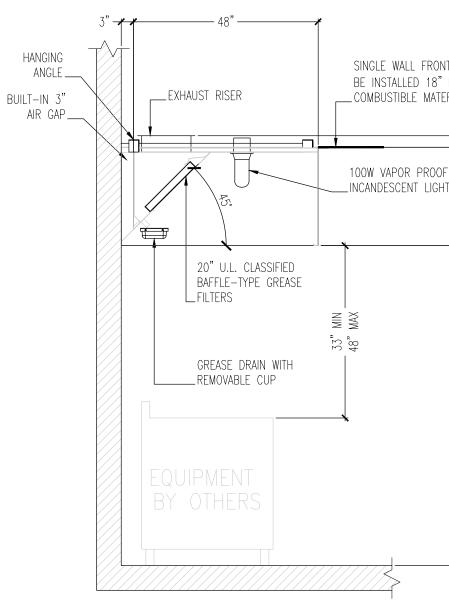
FILTER ASSEMBLY NOT TO SCALE

## VAPOR PROOF LIGHT NOT TO SCALE

WDTH LENGTH DIA. S.P. Q		EVAPORATIVE COOLER "EC"							
	ΓY	QTY	S.P.	DIA.	LENGTH	MDTH			
31.00 31.00 35.00 0.42	1	1	0.42	35.00	31.00	31.00			


HANGING ANGLE LOCATIONS						
HOOD STYLE	DIM FROM REAR	DIM FROM FRONT	DIM FROM FRONT			
		24"	30"			
WALL						
EXHAUST ONLY	1.75"	11.25"	5.25"			
WITH MAKE UP AIR	1.75"	2.75"	2.75"			
BACK SHELF						
EXHAUST ONLY	1.75"	11.25"	5.25"			
WITH MAKE UP AIR	1.75"	2.75"	2.75"			
CONDENSATE		10.50"				

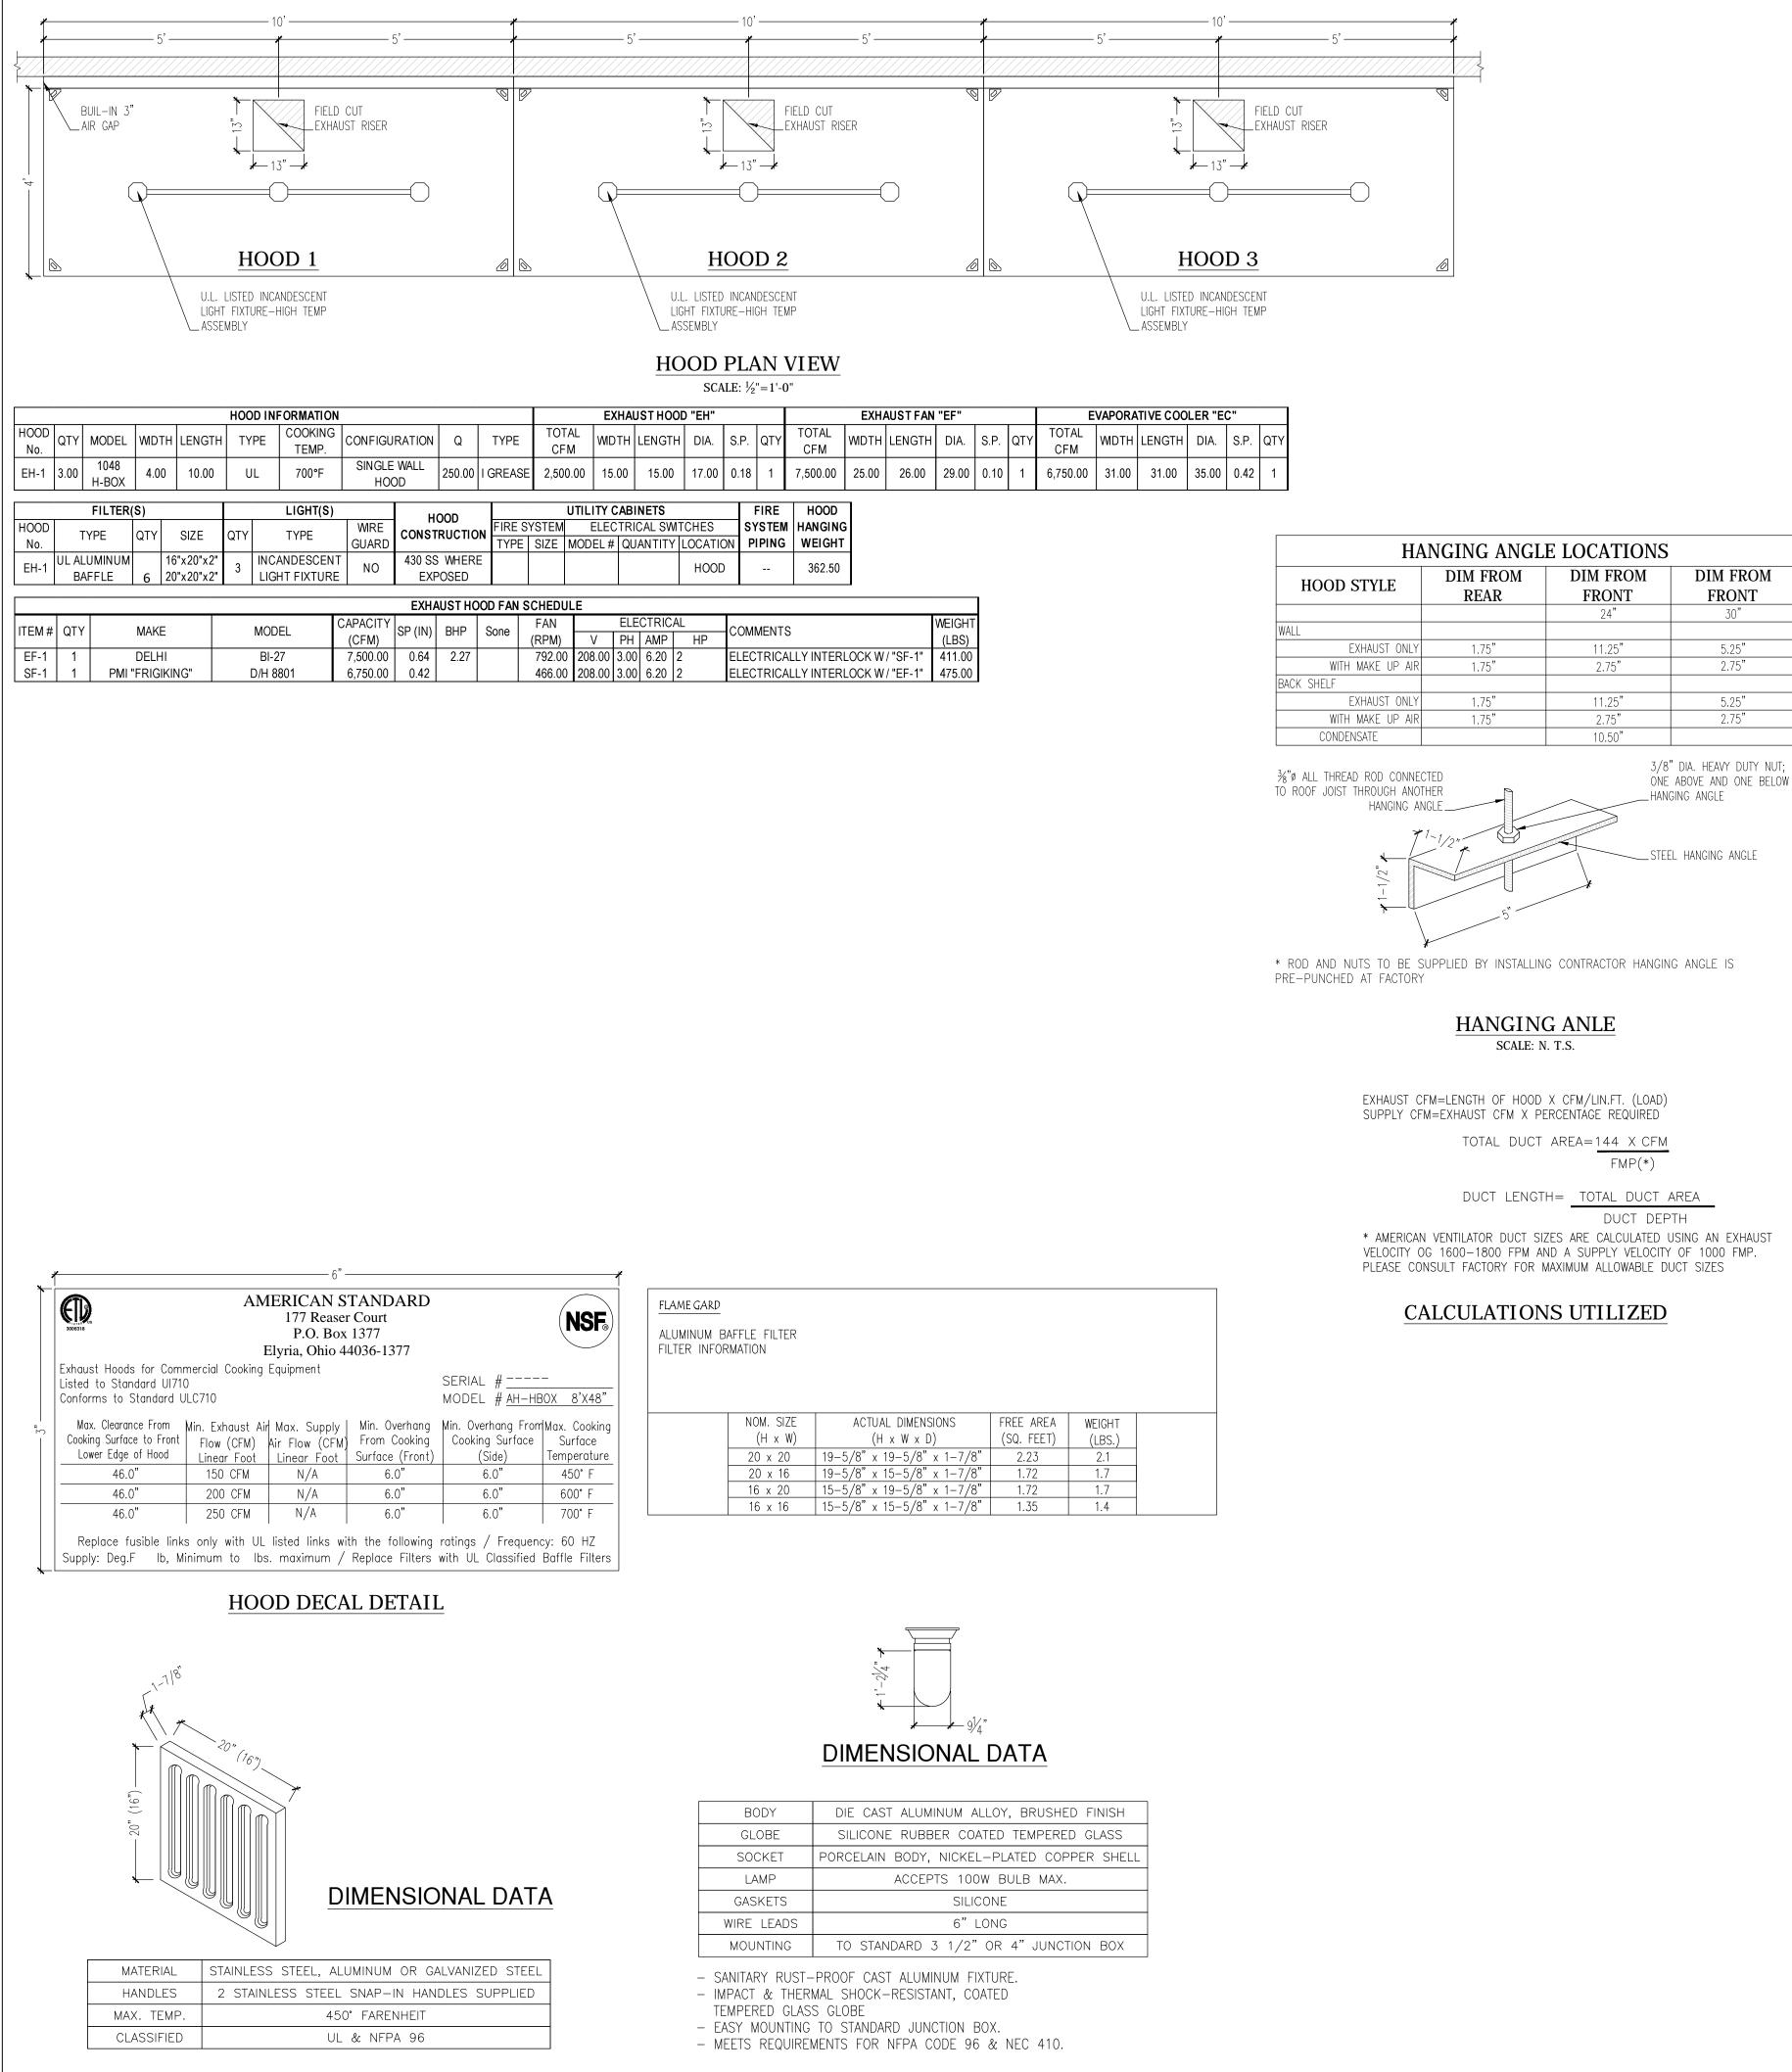
\* AMERICAN VENTILATOR DUCT SIZES ARE CALCULATED USING AN EXHAUST




IT IS THE RESPONSIBILITY OF THE ARCHITECT/OWNER TO ENSURE THAT THE HOC CLEARANCE FROM LIMITED-COMBUSTIBLE AND COMBUSTIBLE MATERIALS IS IN CC WITH LOCAL CODE REQUIREMENTS


# SIDE VIEW

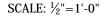

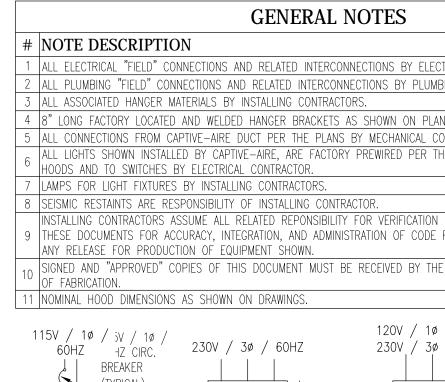

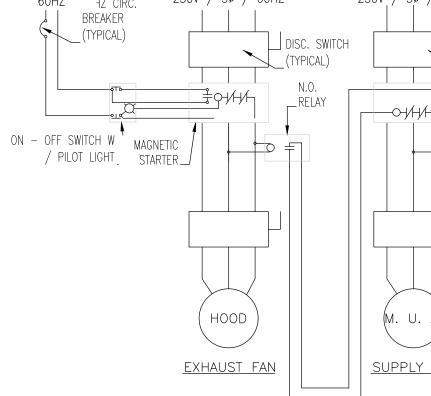

# EF, SF & FIRE PUMP WIRI

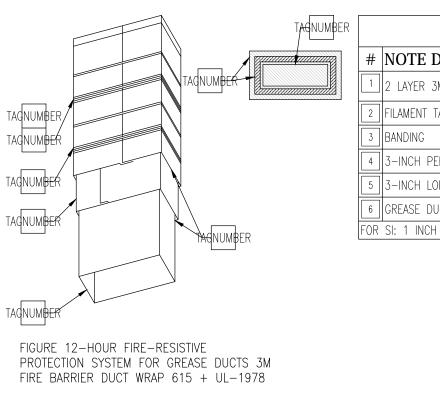

FIRE WRAP DETAIL 615 + UL-1978

IT MUST FROM ERIALS	177	REASER COURT ELYRIA, OHIO OLL FREE : 1-	<b>AS, I</b> 440 -800	NC. P.O.BOX 36-1377 -854-32	1377	DESIGN BY <b>JIS BROTHERS</b> 12368 E VALLEY BLVD, UNIT 115 EL MONTE, CA91732
80" AFF TYP		PHONE: 440 FAX: 440- DEAR S 15455 Jeffr CA 9	-365  HEN ey R	-2100 NGDU Id, Irvine		Eric Li 526 S Atlantic Blvd. #C Monterey Park, CA 91754 (626) 257-0849 / (626) 400-5771 Jisbrothers@gmail.com
DOD OMPLIANCE	DRAWN BY: DATE: APP'D BY:	JH 04/07/2015	#	REVISI Date	ONS BY	
TRICAL CONTRACT		allation Drawings Bo Representativ	ised 0 es of	n Drawings I OWNER	Provided By	The drawings and specifications and the ideas, designs an arrangements represented thereby are and shall remain the property of the copyright holders. They are for the sole purpose of demonstration of technology and workflows and are not guaranteed or waranteed for us for construction. No part thereof shall be copied, disclosed to others or used in connection with any work or project or by any other person for any purpose without the written consent of ERIC LI. Visual contact with these drawings of specifications shall constitute conclusive evidence of acceptance of these restrictions.
OF DIMENSIONAL REQUIREMENTS IN FACTORY PRIOR / 60HZ / 60HZ J DISC. S (TYPICA N.	CONNECTIONS BETWEEN DATA CONTAINED ON N EFFECT PRIOR TO R TO COMMENCEMENT 115V / 1ø / 60HZ					PROJECT NAME / ADDRESS: DEAR SHENGDU 15455 Jeffrey Rd, Irvine CA 92618
A. FAN ENG ERIMETER OVERLA DINGITUDINAL OVER JCT E 25.4 MM	DUCT WRAP 615 +			COMPC AMERICAN HO ARE BUILT IN WITH NFPA <u>#</u> AND ARE RE ONE OR MORI INTERNATION	T IS UL LISTED DNENTS OOD SYSTEMS N COMPLIANCE #96 & UL710 COGNIZED BY E OF THE NSF ALFOLLOWING: TL	No.     Revision/Issue     Date  068       SHEET CONTENT       Exhaust Hood Cutsheet

